

PROJECT:

SITE NAME:

NEW BUILD LSC MCNUTT

LOCATION CODE:

300209

PROJECT INFORMATION

REQUIRED-ALLOWED

NO

NO

UP TO 50 FEET

JP TO 9000 SQ.

NOT APPLICABLE

1 HOUR

1 HOUR

NOT APPLICABLE

NOT APPLICABLE

CLASS B

APPLICABLE CODES AND STANDARDS

THE FOLLOWING CODES. NOTHING IN THESE PLANS IS TO BE CONSTRUED TO PERMIT WORK NO

ADA COMPLIANCE: THIS FACILITY IS UNMANNED AND NOT FOR HUMAN HABITATION LANDINGS AND EXITS

FCC REGARDING PHYSICAL AND ELECTROMAGNETIC INTERFERENCE. THE ONLY SIGNAGE WHICH IS

HEALTH ISSUES: EVERY WIRELESS TELECOMMUNICATIONS FACILITY SHALL MEET HEALTH AND SAFETY

COMMISSION OR ANY SUCCESSOR THEREOF, AND ANY OTHER FEDERAL OR STATE AGENCY

WILL NOT INTERFERE WITH OPERATION OF OTHER COMMUNICATION DEVICES.

CC COMPLIANCE: EVERY WIRELESS TELECOMMUNICATIONS FACILITY SHALL MEET THE REGULATIONS OF THE

STANDARDS FOR ELECTROMAGNETIC FIELD EMISSIONS AS ESTABLISHED BY THE FEDERAL COMMUNICATIONS

PERMITTED IS THAT WHICH IS REQUIRED BY STATE OR FEDERAL LAW, RADIATION FROM THIS FACILITY

NFPA 70 - NATIONAL ELECTRIC CODE, 2014 EDITION AS ADOPTED BY LOCAL JURISDICTION

NONE

PROJECT NUMBER: STRUCTURE TYPE:

INTERNATIONAL BUILDING CODE, 2009 EDITION

SHALL COMPLY WITH ALL APPLICABLE BUILDING CODES.

AS ADOPTED BY LOCAL JURISDICTION

201041085225 80' MONOPOLE TOWER

ADDRESS:

100 AIRPORT ROAD

SANTA TERESA, NM 88008

PROVIDED

NO

NOT APPLICABL

NOT APPLICABLE

NOT APPLICABLE

NOT APPLICABL

UNOCCUPIED

NOT APPLICABLE


NOT APPLICABLE

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NOT APPLICABLE

UNOCCUPIED, NO PLUMBING



09/11/2017

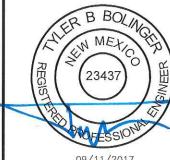PE RENEWAL DATE DECEMBER 31, 2017

DRAWINGS INDEX

REVISION

GENERAL SHEETS

IVII SURVEY

CIVIL PLANS

UR1

YES

YES

YES

YES

YES

YES YES

YES

YES

YES YES

YES

TITLE SHEET

PHOTO SHEET

SURVEY

SPECIFICATION SHEET

OVERALL SITE PLAN

DETAILED SITE PLAN

GRADING PLAN

CIVIL DETAILS

CIVIL DETAILS

CIVIL DETAILS

CIVIL DETAILS

ONE-LINE DIAGRAM

FLECTRICAL DETAILS

ELECTRICAL SITE PLAN

GROUNDING SITE PLAN

GROUNDING DETAILS

GROUNDING DETAILS

GROUNDING DETAILS

GROUNDING DETAILS

GROUNDING DETAILS

ANTENNA INFORMATION

NOTE: DRAWING SCALES ARE FOR 11"X17" SHEETS

UTILITY COORDINATION SITE PLAN

FLECTRICAL AND GROUNDING NOTES

ELECTRICAL PLANS

GROUNDING PLANS

RF INFORMATION

TOWER FLEVATION

ABBREVIATIONS AND SYMBOLS

PROJECT SUMMARY

APPLICANT:

VERIZON WIRELESS 4821 FURANK NF ALBUQUERQUE, NM 87111 CONTACT: JEFF DEWALT PHONE: 505.250.0004

SITE ACQUISITION:

KGI WIRELESS, INC. CONTACT: RYAN HAVENHILL PHONE: 512.334.3213 RYAN.HAVENHILL@KGIWIRELESS.COM

ENGINEER:

KGI WIRELESS, INC. BUILDING THREE, SUITE 370 805 LAS CIMAS PKWY. AUSTIN, TX 78746 TYLER BOLINGER, P.E. PRINCIPAL ENGINEER PHONE: 512.334.3256

SURVEYOR:

CLAUSEN LAND SURVEYING, LLC 5328 COUNTRY OAKS DR EL PASO, TEXAS 79932 915.355.9482

TOWER OWNER:

VERIZON WIRELESS 126 W GEMINI DRIVE TEMPE, AZ 85283

LATITUDE AND LONGITUDE(NAD83)

31° 51′ 48.529″ N 106° 39' 19.435" W

ELEVATION

3841

COUNTY: DONA AÑA

JURISDICTION:

STATE OF NEW MEXICO POWER COMPANY:

FL PASO FLECTRIC 201 NORTH WATER STREET LAS CRUCES, NEW MEXICO 88001 575.523.3630

AAV PROVIDER:

CONTERRA

PUBLIC RECORD PARCEL NO:

17-03880



DRIVING DIRECTIONS

FROM ALBUQUERQUE, NM PROCEED TO ON I-25 S. FOLLOW I-25 S TO LAS CRUSES. MERGE ONTO I-10 S. FOLLOW I-10 S TO TX-178/ARTCRAFT RD/PASEO DEL NORTE. MERGE ONTO S DESERT BLVD. CONTINUE TO NM-136 W. TURN LEFT ON NM-273 S/MCNUTT RD. TURN RIGHT ONTO AIRPORT RD. TAKE AIRPORT ROAD 1 MI. SITE IS ON RIGHT.

CCUPANCY CLASSIFICATION: FIRE SPRINKLERS FIRE ALARM: UII DING HEIGH BUILDING STORIES BUILDING AREA OCCUPANT LOAD: IUMBER OF EXITS FIRE RESISTANCE OF EXTERIOR WALLS: TRE RATING OF BUILDING ELEMENTS ROTECTION OF OPENINGS ION-SEPERATED OR SEPARATED USES ROOF COVERING MATERIAL: PLUMBING FIXTURES ALL WORK SHALL BE PERFORMED AND MATERIALS INSTALLED IN ACCORDANCE WITH THE CURRENT EDITIONS CONFORMING TO THESE CODES

SCOPE OF WORK

THIS WIRELESS COMMUNICATIONS FACILITY IS NOT INTENDED FOR HUMAN

THE SCOPE OF WORK CONSISTS OF MODIFYING THE EXISTING WIRELESS

THIS FACILITY DOES NOT REQUIRE POTABLE WATER AND WILL NOT

EQUIPMENT CABINETS ON CONCRETE FOUNDATION

OCCUPANCY

INSTALLATION:

PRODUCE ANY SEWAGE

A. 80' MONOPOLE CELLULAR TOWER

COMPOUND SURFACING & FENCE

ELECTRICAL AND CIVIL CONSTRUCTION

GENERAL PROJECT NOTES PRIOR TO SUBMITTING A BID, THE CONTRACTOR SHALL BE FAMILIAR WITH THE SCOPE OF WORK AND

ALL CONDITIONS AFFECTING THE NEW PROJECT. . CONTRACTOR SHALL VERIFY ALL FIELD CONDITIONS AND DIMENSIONS OF THE JOB SITE AND CONFIRM THAT WORK AS INDICATED ON THESE CONSTRUCTION DOCUMENTS CAN BE ACCOMPLISHED AS SHOWN

PRIOR TO COMMENCEMENT OF ANY WORK. 3. ALL FIELD MODIFICATIONS BEFORE, DURING, OR AFTER CONSTRUCTION SHALL BE APPROVED IN WRITING BY A VERIZON WIRELESS REPRESENTATIVE.

. INSTALL ALL EQUIPMENT AND MATERIALS PER THE MANUFACTURER'S RECOMMENDATIONS, U.N.O. NOTIFY VERIZON WIRELESS, IN WRITING, OF ANY MAJOR DISCREPANCIES REGARDING THE CONTRACT DOCUMENTS, EXISTING CONDITIONS, AND DESIGN INTENT. THE CONTRACTOR SHALL BE RESPONSIBLE FOR OBTAINING CLARIFICATIONS FROM A VERIZON WIRELESS REPRESENTATIVE AND ADJUSTING THE BID ACCORDINGLY.

CONTRACTOR SHALL BE SOLELY RESPONSIBLE FOR ALL CONSTRUCTION MEANS, METHODS, TECHNIQUES, SEQUENCES, AND PROCEDURES OF THE WORK UNDER THE CONTRACT.

CONTRACTOR SHALL PROTECT ALL EXISTING IMPROVEMENTS AND FINISHES THAT ARE TO REMAIN. CONTRACTOR SHALL REPAIR ANY DAMAGE THAT MAY OCCUR DURING THE CONSTRUCTION TO THE SATISFACTION OF A VERIZON WIRELESS REPRESENTATIVE.

. THE CONTRACTOR IS RESPONSIBLE FOR RED-LINING THE CONSTRUCTION PLANS TO ILLUSTRATE THE AS BUILT CONDITION OF THE SITE. FOLLOWING THE FINAL INSPECTION BY VERIZON WIRELESS, THE CONTRACTOR SHALL PROVIDE VERIZON WIRELESS WITH ONE COPY OF ALL RED-LINED DRAWINGS.

VERIFY ALL FINAL EQUIPMENT WITH A VERIZON WIRELESS REPRESENTATIVE. ALL EQUIPMENT LAYOUT SPECS, PERFORMANCE INSTALLATION AND THEIR FINAL LOCATION ARE TO BE APPROVED BY VERIZON WIRELESS. THE CONTRACTOR SHALL BE RESPONSIBLE FOR COORDINATING HIS/HER WORK WITH THE WORK AND CLEARANCES REQUIRED BY OTHERS RELATED TO SAID INSTALLATIONS

verizon



805 LAS CIMAS PKWY AUSTIN, TX 78746

TEL: 512.345.9595 FAX: 512.345.9898

SITE NAME:

LSC MCNUTT

LOCATION CODE:

300209

SITE ADDRESS: 100 AIRPORT ROAD SANTA TERESA, NM 88008

THESE DRAWINGS ARE THE PROPERTY OF VERIZON WIRELESS. THEY ARE INTENDED FOR THE EXCLUSIVE USE OF THIS PROJECT ONLY ANY RE-USE OF THESE PLANS (DRAWINGS) WITHOUT THE EXPRESS WRITTEN CONSENT OF VERIZON WIRELESS IS PROHIBITED.

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TITLE SHEET

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GENERAL PROJECT NOTES:

- CONTRACTOR IS RESPONSIBLE FOR ERECTING TEMPORARY BARRICADES AND/OR FENCING TO PROTECT
 THE SAFETY OF THE PUBLIC DURING CONSTRUCTION. THE CONTRACTOR SHALL REMOVE ALL
 TEMPORARY BARRIERS AND REPAIR ALL DAMAGE TO PROPERTY ON THE SITE CAUSED BY THIS
 CONSTRUCTION. THE COST OF REPAIR IS THE CONTRACTOR'S RESPONSIBILITY.
- 2. ALL WORK SHALL BE IN ACCORDANCE WITH APPLICABLE LOCAL, STATE, AND FEDERAL REQUIREMENTS.
- 3. THE CONTRACTOR SHALL BE RESPONSIBLE FOR VERIFICATION OF ALL MEASUREMENTS AT THE SITE PRIOR TO ORDERING ANY MATERIALS OR CONDUCTING ANY WORK.
- 4. EXCESS SOIL MATERIAL AND DEBRIS CAUSED BY THIS CONSTRUCTION SHALL BE REMOVED FROM THE SITE AND DISPOSED OF IN A LEGAL MANNER.
- CONTRACTOR SHALL MAKE ADJUSTMENTS TO GRADING ELEVATIONS AS NECESSARY TO ENSURE A SITE FREE OF DRAINAGE PROBLEMS.
- 6. CONTRACTOR SHALL COORDINATE A CONSTRUCTION LAY-DOWN AREA WITH THE PROPERTY OWNER. CONSTRUCTION LAY-DOWN AREA SHALL BE FENCED—IN WITH TEMPORARY (45 DAY) CONSTRUCTION FENCE. THE TEMPORARY FENCE SHALL BE CONSTRUCTED OF 6' HIGH CHAIN LINK FABRIC AND IS TO BE REMOVED AT THE END OF CONSTRUCTION. LAY-DOWN AREA IS TO BE RESTORED TO ITS ORIGINAL CONDITION AFTER FENCE REMOVAL.
- SURVEY INFORMATION SHOWN WAS CREATED FROM RECORD INFORMATION AND DOES NOT CONSTITUTE
 A LEGAL BOUNDARY SURVEY.
- 8. THESE PLANS DO NOT ADDRESS THE SAFETY AND STABILITY OF THE STRUCTURE DURING ASSEMBLY AND ERECTION, WHICH ARE THE RESPONSIBILITY OF THE ERECTOR, BASED ON THE MEANS AND METHODS CHOSEN BY THE FRECTOR
- NEW EQUIPMENT COMPOUND SHALL BE COVERED W/ 4" CRUSHED ROCK INSTALLED OVER CLIENT—APPROVED WEED BARRIER MATERIAL (IF APPLICABLE).

GENERAL CONTRACTOR NOTES:

 THE CONTRACTOR SHALL BE RESPONSIBLE FOR THE COMPLETE PROJECT SCOPE OF WORK DEFINED UNDER THE REQUEST FOR PROPOSAL (RFP) FOR THIS PROJECT AND ALL ASSOCIATED ATTACHMENTS AND DOCUMENTS PROVIDED.

THE RFP AND ALL ASSOCIATED DOCUMENTS SHALL DEFINE THE COMPLETE PROJECT SCOPE OF WORK. CONTRACTOR SHALL BE RESPONSIBLE FOR COMPLIANCE WITH ALL DOCUMENTS AND IS SOLELY RESPONSIBLE FOR ALL WORK.

ALL DOCUMENTS INCLUDED WITHIN THE PROJECT REQUEST FOR PROPOSAL ARE REQUIRED FOR THE COMPLETE PROJECT SCOPE OF WORK. THE CONTRACTOR SHALL BE RESPONSIBLE FOR ALL WORK (EQUIPMENT, MATERIAL, INSTALLATION, TESTING, ETC.) INDICATED IN ALL DOCUMENTS. THE RFP, VERIZON WRELESS NETWORK STANDARDS AND PROJECT ADDENDUMS AND CLARIFICATIONS ARE COMPLEMENTARY TO EACH OTHER. THE FORMAT OF THE SPECIFICATIONS AND DRAWING NUMBERING PER DISCIPLINE IS NOT INTENDED TO IMPLY SEGREGATION OF SUB CONTRACTOR WORK. CONTRACTOR SHALL ASSIGN ALL SUB CONTRACTOR WORK AND VERIZON WRELESS WILL NOT ACCEPT ANY CHANGE ORDERS FOR INTERNAL CONTRACTOR WORK ASSIGNMENTS.

CONTRACTOR SHALL BE RESPONSIBLE FOR DISTRIBUTING ALL RFP DOCUMENTS TO THEIR SUB-CONTRACTORS. ALL RFP DOCUMENTS ARE REQUIRED TO INDICATE THE PROJECT SCOPE OF WORK. PARTIAL SUB-CONTRACTOR DOCUMENT PACKAGES ARE HIGHLY DISCOURAGED.

IN THE EVENT OF A CONFLICT BETWEEN THE DRAWNGS, SPECIFICATIONS, REFERENCED STANDARDS, VERIZON WRELESS STANDARDS, OR AGREEMENT TERMS AND CONDITIONS THE ARCHITECT/ENGINEER SHALL BE CONTACTED FOR FORMAL INTERPRETATION OF THE REQUIREMENTS. THE CONTRACTOR SHALL BE DEEMED TO HAVE PROVIDED THE DETAILED AND EXTENSIVE INTERPRETATION. ANY WORK INSTALLED IN CONFLICT WITH THE ARCHITECT/ENGINEER INTERPRETATIONS SHALL BE CORRECTED BY THE CONTRACTOR AT NO EXPENSE TO VERIZON WIRELESS.

- 2. ALL ANTENNAS MUST BE PIM TESTED WITHIN 48 HOURS OF THEM BEING RECEIVED BY THE INSTALLATION CONTRACTOR. THOSE RESULTS MUST BE SENT BACK TO THE VERIZON WIRELESS CONSTRUCTION ENGINEER AND EQUIPMENT ENGINEER WITHIN THE SAME 48 HOURS. IF YOU MISS THE 48HR TIMELINE AND THE ANTENNAS DO NOT PASS UPON INSTALLATION, YOUR COMPANY WILL BE CHARGED FOR THE COST OF THE ANTENNAS FOR REPLACEMENT.
- ALL LOADS MUST BE SECURED PROPERLY TO THE VEHICLE OR TRAILER. VERIZON WIRELESS WILL PASS ALONG THE COST OF ANY REPLACEMENTS DUE TO DAMAGE OR LOSS WHETHER IT IS NEW OR USED.
- ALL VENDORS ARE REQUIRED TO SHOW UP TO THE DC IN TEMPE, OR DELTA/KING COMMUNICATIONS, OR BROKEN ARROW IN NM WITH ENCLOSED TRANSPORTATION FOR ALL ELECTRONICS.

ANTENNA, MOUNTS AND HARDWARE INSTALLATION NOTES:

- CONTRACTOR TO INSTALL ANTENNAS, MOUNTS AND TOWER HARDWARE PER MANUFACTURER'S RECOMMENDATIONS (OR AS REQUIRED BY THE OWNER/PROWDER).
- 2. ALL BOLTS SHALL BE TIGHTENED PER AISC REQUIREMENTS (SEE STEEL NOTES).
- ANY GALVANIZED SURFACES THAT ARE DAMAGED BY ABRASIONS, CUTS, DRILLING OR FIELD WELDING DURING SHIPPING OR ERECTION SHALL BE TOUCHED—UP WITH TWO COATS OF COLD GALVANIZING COMPOUND MEETING THE REQUIREMENTS OF ASTM A780.
- ANTENNA MOUNTS SHALL NOT BE USED AS A CLIMBING DEVICE. WORKERS SHALL ALWAYS TIE OFF TO AN APPROVED CLIMBING POINT.
- 5. SEE ALSO GENERAL ANTENNA NOTES ON SHEET RF1 (IF APPLICABLE)

STRUCTURAL DESIGN CRITERIA:

ALL LOADS DERIVED FROM REQUIREMENTS OF INTERNATIONAL BUILDING CODE 2009, ASCE 7-05, "MINIMUM DESIGN LOADS FOR BUILDINGS AND OTHER STRUCTURES" & ANSI TIA-222-G "STRUCTURAL STANDARD FOR ANTENNA SUPPORTING STRUCTURES AND ANTENNAS".

BUILDING STRUCTURES:

- 1. WIND LOADS: IBC 2009 \$1609 & ASCE 7-05 \$6.4 (SIMPLIFIED METHOD) V3s = 90 MPH
- OCCUPANCY CAT. = II; EXPOSURE CAT. = C; IMPORTANCE FACTOR = 1.0
- 2. SEISMIC LOADS: IBC 2009 §1613 & ASCE 7-05 §12.14 (SIMPLIFIED METHOD) OCCUPANCY CAT. = II; SITE CLASS = D V=F(S DS)W/R

F = 1.0 (SINGLE-STORY), 1.1 (TWO STORY), 1.2 (THREE STORY)

Sds = (2/3) Sms

- R = 1.5 (ORDINARY PLAIN CONCRETE SHEARWALLS),
 - 6.5 (LIGHT-FRAMED WALLS W/ WOOD STRUCTURAL PANELS),
 - 4.0 (ORDINARY REINFORCED CONCRETE SHEARWALLS)

COMMUNICATIONS STRUCTURES:

- 1. WND LOADS: IBC 2009 §1609, ASCE 7-05 §6.5.15 & ANSI TIA-222-G V = 90 MPH (3-SEC. GUST) V = 30 MPH (0" RADIAL ICE) STRUCTURE CLASS = II; EXPOSURE CAT. = C; IMPORTANCE FACTOR = 1.0
- 2. SEISMIC LOADS*: IBC 2009 §1613, ASCE 7-05 §15.6.6 & ANSI TIA-222-G *MAY BE IGNORED FOR STRUCTURE CLASS I AND/OR EARTHQUAKE SPECTRAL RESPONSE FOR SHORT PERIOD (Ss) \leq 1.0 STRUCTURAL CLASS = II; OCC. CAT. = II; SITE CLASS = D; IMPORTANCE FACTOR = 1.0 V = Sds(W)//R (EQUIVALENT LATERAL FORCE PROCEDURE (METHOD 1)) V = Σ Soz(Wz)//R (EQUIVALENT MODAL ANALYSIS PROCEDURE (METHOD 2))

STEEL NOTES:

 ALL STEEL SHALL BE GALVANIZED PER ASTM A 123 & CONFORM TO THE FOLLOWING MINIMUM SPECIFICATIONS:

HSS SHAPES (TUBE) ASTM A500, GR. B (46 KSI)
HSS SHAPES (ROUND) ASTM A500, GR. B (42 KSI)
W-SHAPES ASTM A992, (50 KSI)
CHANNELS, ANGLES & PLATES ASTM A36

- ALL BOLTS SHALL BE GALVANIZED PER ASTM A153 AND CONFORM TO ASTM A325 U.N.O. ALL BOLTED CONNECTIONS SHALL BE EQUIPPED WITH AN APPROVED NUT-LOCKING DEVICE.
- ALL WELDING WORK SHALL CONFORM TO THE AWS D1 .1 STRUCTURAL WELDING CODE. ALL WELDING SHALL BE PERFORMED BY CERTIFIED WELDERS ONLY. WELDING ELECTRODES SHALL BE E70XX.
- ALL DETAILING, FABRICATION AND ERECTION OF STRUCTURAL STEEL SHALL CONFORM TO AISC SPECS AND CODES, LATEST EDITION.
- 5. AT HIS OWN DISCRETION, THE CONTRACTOR MAY SUBMIT DETAILED, ENGINEERED, COORDINATED AND CHECKED SHOP DRAWNOS FOR ALL STRUCTURAL STEEL TO THE ENGINEER OF RECORD TO REVIEW FOR COMPLIANCE WITH DESIGN INTENT PRIOR TO THE START OF FABRICATION AND/OR ERECTION. THE ENGINEER IS ABSOLVED OF ALL LIABILITY ASSOCIATED WITH THE MISINTERPRETATION OF THE CONSTRUCTION DOCUMENTS IF CONTRACTOR CHOOSES NOT TO SUBMIT SHOP DRAWNOS.
- 6. TORCH-CUTTING OF ANY KIND SHALL NOT BE PERMITTED.
- 7. ALL BOLTS SHALL BE TIGHTENED TO AISC SNUG TIGHT REQUIREMENTS. THE SNUG TIGHT CONDITION IS DEFINED AS THE TIGHTNESS THAT EXISTS WHEN ALL PLIES IN A JOINT ARE IN FIRM CONTACT. THIS MAY BE ATTAINED BY A FEW IMPACTS OF AN IMPACT WRENCH OR THE FULL EFFORT OF A MAN USING AN ORDINARY SPUD WRENCH.

FOUNDATION NOTES:

- 1. THE CONTRACTOR SHALL READ THE GEOTECHNICAL REPORT (IF AVAILABLE) AND SHALL CONSULT THE GEOTECHNICAL ENGINEER AS NECESSARY PRIOR TO CONSTRUCTION.
- THE GEOTECHNICAL ENGINEER (OR INSPECTOR) SHALL INSPECT THE EXCAVATION PRIOR TO THE PLACEMENT OF CONCRETE AND SHALL PROVIDE A NOTICE OF INSPECTION FOR THE BUILDING INSPECTOR FOR REVIEW AND RECORDS PURPOSES.
- 3. THE CONTRACTOR SHALL DETERMINE THE MEANS AND METHODS NECESSARY TO SUPPORT THE EXCAVATION DURING CONSTRUCTION.
- REBAR AT BOTTOM OF FOUNDATIONS SHALL BE BONDED TO SITE GROUNDING SYSTEM (WHEN APPLICABLE). SEE ADDITIONAL DETAILS ON GROUNDING SITE PLAN.
- 5. ALL FOOTINGS TO BE PLACED ON FIRM, UNDISTURBED, INORGANIC MATERIAL. PROOF ROLL SUB-GRADE PRIOR TO PLACING CONCRETE WHERE THE MATERIAL HAS BEEN DISTURBED BY EQUIPMENT. UNACCEPTABLE/DISTURBED MATERIAL SHALL BE OVER-EXCAVATED AND REPLACED WITH "LEAN CONCRETE FILL".
- 6. STRUCTURAL BACKFILL SHALL BE GRANULAR FREE—DRAINING MATERIAL FREE OF DEBRIS, ORGANICS, REFUSE AND OTHERWISE DELETERIOUS MATERIALS. MATERIAL SHALL BE PLACED IN LIFTS NO GREATER THAN 6" IN DEPTH AND COMPACTED TO 95% OF MAXIMUM DENSITY AS DETERMINED PER ASTM D1557 (MODIFIED PROCTOR).

CONCRETE NOTES:

- ALL CONCRETE SHALL BE IN ACCORDANCE WITH CHAPTER 19 OF THE IBC & ACI 318, "BUILDING CODE REQUIREMENTS FOR REINFORCED CONCRETE", LATEST EDITION & HAVE THE FOLLOWING PROPERTIES:
- A. MINIMUM 28-DAY COMPRESSIVE STRENGTH (f'c) OF 4,000 PSI.
- B. CEMENT SHALL BE "LOW-ALKALI" TYPE IIA (MÓDERATE SULFATE RESISTANCE, AIR ENTRAINING) CONFORMING TO ASTM C150.
- C. MAXIMUM WATER/CEMENT RATIO OF 0.45 AND AIR-ENTRAINED 4% TO 7%.
- D. CONCRETE PROPORTIONING SHALL BE DESIGNED BY AN APPROVED LABORATORY. TOLERANCES IN ACCORDANCE WITH ACI 117. COPIES OF CONCRETE MIX SHALL BE SUBMITTED TO THE ENGINEER FOR REVIEW PRIOR TO PLACEMENT.
- E. ALL AGGREGATE USED IN CONCRETE SHALL CONFORM TO ASTM C33. USE ONLY AGGREGATES KNOWN NOT TO CAUSE EXCESSIVE SHRINKAGE. MAXIMUM AGGREGATE SIZE TO BE 1)2".
- F. MAXIMUM SLUMP: 3" (FOUNDATION, FOOTING, SLAB), 4" (WALL, COLUMN, BEAM)
- 2. FORMWORK FOR CONCRETE SHALL CONFORM TO ACI 347. TOLERANCES FOR FINISHED CONCRETE SURFACES SHALL MEET CLASS-C REQUIREMENTS. IN NO CASE SHALL FINISHED CONCRETE SURFACES EXCEED THE FOLLOWING VALUES AS MEASURED FROM NEAT PLAN LINES AND FINISHED GRADES: ± 1/4" VERTICAL, ± 1" HORIZONTAL.
- 3. CHAMFER ALL EXPOSED CORNERS AND FILLET ENTRANT ANGLES 3/4" U.N.O.
- CONCRETE FINISHING:
- A. FLOORS: CONCRETE FLOOR SLABS SHALL BE FINISHED IN ACCORDANCE WITH ACI 302.1 CHAPTER 8. PROVIDE CLASS 4 FINISH U.N.O. PROVIDE NON-SLIP FINISH FOR EXTERIOR SURFACES.
- B. OTHER SURFACES: CONCRETE SURFACES SHALL BE FINISHED IN ACCORDANCE WITH ACI 301 SECTIONS 5.3, 6.3, AND 7.3. PROVIDE ROUGH FINISH FOR ALL SURFACES NOT EXPOSED TO VIEW AND SMOOTH FINISH FOR ALL OTHERS, U.N.O.
- 5. A MINIMUM OF ONE (1) SET OF CONCRETE CYLINDERS SHALL BE TAKEN PER TRUCK (IF REQUIRED BY SPECIAL INSPECTIONS). EACH SET SHALL CONSIST OF THREE (3) CYLINDERS. ONE (1) SHALL BE TESTED AT 7 DAYS, TWO (2) SHALL BE TESTED AT 28 DAYS. ALL CYLINDERS SHALL BE TAKEN, PREPARED AND TESTED BY A TESTING LAB IN ACCORDANCE WITH ASTM C172, C31 AND C39.

REINFORCING STEEL NOTES:

- 1. ALL REINFORCING STEEL SHALL CONFORM TO ASTM A615. VERTICAL/HORIZONTAL BARS SHALL BE GRADE 60; TIES OR STIRRUPS SHALL BE A MINIMUM OF GRADE 40. ALL REINFORCING STEEL SHALL HAVE 3" (± 3/8") OF CONCRETE COVER, U.N.O.
- ALL BAR BENDS, HOOKS, SPLICES AND OTHER REINFORCING STEEL SHALL CONFORM TO THE REQUIREMENTS OF ACI 315.
- ALL BARS SHALL BE SPLICED WITH A MINIMUM LAP OF 48 BAR DIAMETERS, LAP SPLICES OF DEFORMED BARS IN TENSION ZONES SHALL BE CLASS—B SPLICES. WELDING OF BARS IS NOT PERMITTED.
- AT ALL CORNERS AND WALL INTERSECTIONS, PROVIDE BENT HORIZONTAL BARS TO MATCH THE HORIZONTAL REINFORCING STEEL.
- PROVIDE VERTICAL DOWELS IN FOOTINGS AND AT CONSTRUCTION JOINTS TO MATCH VERTICAL REINFORCING BAR SIZE AND SPACING.
- 6. ACI-APPROVED PLASTIC-COATED BAR CHAIRS OR PRECAST CONCRETE BLOCKS SHALL BE PROVIDED FOR SUPPORT OF ALL GRADE-CAST REINFORCING STEEL & SHALL BE SUFFICIENT IN NUMBER TO PREVENT SAGGING. METAL CLIPS OR SUPPORTS SHALL NOT BE PLACED IN CONTACT WITH THE FORMS OR THE SUB-GRADE.
- 7. DOWELS AND ANCHOR BOLTS SHALL BE WRED OR OTHERWISE HELD IN CORRECT POSITION PRIOR TO PLACING CONCRETE. IN NO CASE SHALL DOWELS OR ANCHOR BOLTS BE "STABBED" INTO FRESHLY-POURED CONCRETE.



09/11/2017

PE RENEWAL DATE DECEMBER 31, 2017





KGI WIRELESS, INC. 805 LAS CIMAS PKWY BUILDING THREE, SUITE 370 AUSTIN, TX 78746

> TEL: 512.345.9595 FAX: 512.345.9898

> > SITE NAME:

LSC MCNUTT

LOCATION CODE:

300209

SITE ADDRESS: 100 AIRPORT ROAD SANTA TERESA, NM 88008

THESE DRAWINGS ARE THE PROPERTY OF VERIZON WIRELESS. THEY ARE INTENDED FOR THE EXCLUSIVE USE OF THIS PROJECT ONLY ANY RE-USE OF THESE PLANS (DRAWINGS) WITHOUT THE EXPRESS WRITTEN CONSENT OF VERIZON WIRELESS IS PROHIBITED.

SUED	FOR:				DATE
VIEW	REV	В			10/18/2010
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NO	DESCRIPTION	BY	DATE
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SHEET TITLE:

SPECIFICATION SHEET


SHEET NUMBER:

SP1



VIEW OF LEASE AREA (LOOKING NORTHWEST)

SCALE: N.T.S.

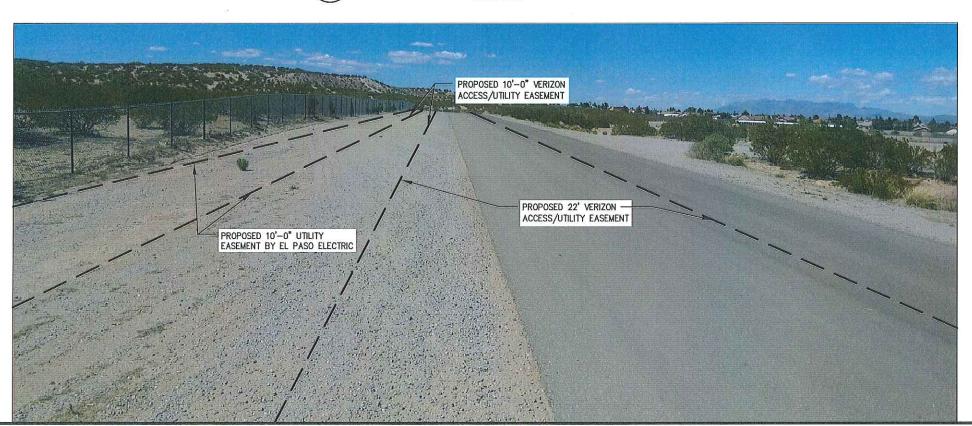

SITE ENTRANCE ROAD (LOOKING NORTH)

SCALE: N.T.S.



PE RENEWAL DATE DECEMBER 31, 2017





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| ISSUED FOR: DATE | REVIEW REV B | 10/18/2016 | REVIEW REV C | 04/03/2017 | CONSTRUCTION REV 0 | 07/20/2017 | CONSTRUCTION REV 1 | 09/11/2017 | REVISION | REVISION |

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SHEET TITLE:

PHOTO SHEET

SHEET NUMBER:

PS1

ABBREVIATION	DEFINITION	ABBREVIATION	DEFINITION
AAV AB	ACCELERATED ACCESS VENDOR	MAX MB	MAXIMUM MACHINE BOLT
ABV	ANCHOR BOLT ABOVE	MECH	MACHINE BOLT MECHANICAL
ACCA	ANTENNA CABLE COVER ASSEMBLY	MFR	MANUFACTURER
ADD'L	ADDITIONAL	MGB	MASTER GROUND BAR
AFF	ABOVE FINISHED FLOOR	MIN MISC	MINIMUM MISCELLANEOUS
AFG AGL	ABOVE FINISHED GRADE ABOVE GRADE LEVEL	MTL	METAL
ALT	ALTERNATE	(N)	NEW
ALUM	ALUMINUM	NO (#)	NUMBER
AMSL	ABOVE MEAN SEA LEVEL	NTS	NOT TO SCALE
ANT	ANTENNA APPROXIMATE	OC OE/OT	ON CENTER
APPROX	APPROXIMATE	OPNG	OVERHEAD ELECTRIC/TELCO OPENING
ARCH	ARCHITECT(URAL)	ф	PHASE (ELECTRICAL)
AWG	AMERICAN WIRE GAUGE	(P)	PROPOSED
B/U BBS	BACK-UP CABINET BATTERY BACK UP STATION	PL .	PLATE OR PROPERTY LINE
BLK	BLOCK	P/C	PRECAST CONCRETE
BLDG	BUILDING	PCS PLY	PERSONAL COMMUNICATION SERVICES PLYWOOD
BLKG	BLOCKING	PPC	POWER PROTECTION CABINET
BTCW BTS	BARE TINNED COPPER WIRE BASE TRANSMISSION STATION	PRC	PRIMARY RADIO CABINET
BM	BEAM	PSI	POUNDS PER SQUARE INCH
BOF	BOTTOM OF FOOTING	PSF PT	POUNDS PER SQUARE FOOT PRESSURE TREATED
BN	BOUNDARY NAILING	PWR	POWER (CABINET)
Q OAD	CENTERLINE	QTY	QUANTITY
CAB CANT	CANTILE VER(ED)	RAD (R)	RADIUS
CIP	CANTILEVER(ED) CAST IN PLACE	RBS	RADIO BASED STATION
CLG	CEILING	REF	REFERENCE
CLR	CLEAR	REQ'D REINF	REQUIRED REINFORCEMENT(ING)
CND COL	CONDUIT COLUMN	RGS	RIGID GALVANIZED STEEL
CONC	CONCRETE	RRH	REMOTE RADIO HEAD
CONN	CONNECTION(OR)	RRU	REMOTE RADIO UNIT
CONT	CONTINUOUS'	SCH SF	SCHEDULE SQUARE FOOT
d	PENNY (NAILS)	SHT	SHEET
DEPT ø	DEPARTMENT DIAMETER	SIM	SIMILAR
DIA	DIAMETER	SPEC	SPECIFICATION(S)
DIAG	DIAGONAL	SQ	SQUARE
DIM	DIMENSION	SS STD	STAINLESS STEEL STANDARD
DBL DF	DOUBLE	STL	STEEL
DWG	DOUGLAS FIR DRAWING(S)	STRUC	STRUCTURAL
(E)	EXISTING	TC	TOWERCLOUD
ÈÁ	EACH	TEMP THK	TEMPORARY THICK(NESS)
EGB	EQUIPMENT GROUND BAR	TMA	TOWER MOUNTED AMPLIFIER
ELEC (EL)	ELECTRICAL	TN	TOE NAIL
ELEV (EL) En	ELEVATION EDGE NAIL	TOA	TOP OF ANTENNA
ENGR	ENGINEER	TOC TOF	TOP OF CURB TOP OF FOUNDATION
EMT	ELECTRICAL METALLIC TUBING	TOP	TOP OF PLATE (PARAPET)
EQ	EQUAL	TOS	TOP OF STEEL
EQUIP Exp	EQUIPMENT EXPANSION	TOW	TOP OF WALL
EXT	EXTERIOR	XFMR	TRANSFORMER
F	FIBER	TYP UE ∕UT	TYPICAL
FAB	FABRICATION(OR)	UG	UNDERGROUND ELECTRIC/TELCO UNDERGROUND
FF FC	FINISH FLOOR	ÜĹ	UNDERWRITERS LABORATORY
FG FN	FINISH GRADE FIBERNET	UNO	UNLESS NOTED OTHERWISE
FOC	FACE OF CONCRETE	VIF	VERIFY IN FIELD
FOM	FACE OF MASONRY	W W/	MDE(MDTH)
FOS	FACE OF STUD	₩/ ₩D	WITH WOOD
FOW FS	FACE OF WALL FINISH SURFACE	WP	WEATHERPROOF
rs FIN	FINISH SURFACE FINISH(ED)	WT	WEIGHT
FLR	FLOOR		
FT (')	FOOT(FEET)		
FTG	FOOTING '		
FND	FOUNDATION		
G GA	GROWTH (CABINET) GAUGE		
GALV	GALVANIZED		
GC	GENERAL CONTRACTOR		
GLB (GLU-LAM)	GLUE LAMINATED BEAM		
GND	GROUND CALLET CIRCUIT INTERPLIPTER		
GFI GPS	GROUND FAULT CIRCUIT INTERRUPTER GLOBAL POSITIONING SYSTEM		
HGR	HANGER		
HDR	HEADER		
HT	HEIGHT		
ICGB	ISOLATED COPPER GROUND BUS		
IN (") INT	INCH(ES) INTERIOR		
L L	LONG(ITUDINAL)		
ĹB	LAG BOLTS		
LB(S) or #	POUND(S)		
LF LTC	LINEAR FEET (FOOT)		
LTE MAS	LONG TERM EVOLUTION MASONRY		
m/J	MUSOUM I		

LINETYPES.

EXISTING LAYER		107	-matiniani	-
PROPOSED LAYER		-		_
CHAIN-LINK FENCE		<u> —о —</u>	0	
BARBED-WRE FENCE	×	—-x-	x	_
OVERHEAD POWER	OE	OE	OE	_
OVERHEAD TELCO	OT	-or $-$	ot	-
UNDERGROUND POWER	UE	—-UE	UE	_
UNDERGROUND TELCO	UT	—-UT	UT	_
UNDERGROUND FIBER	UF		UF	_
UNDERGROUND ALARM	UA	—UA—	UA	_
UNDERGROUND POWER & ALARM	UE&A -	700477400	— UE&A ———	-
INTERIOR ELECTRICAL CONDUIT	E	—Е—	E	_
UNDERGROUND LP FUEL	LP	-LP-	LP	-
COAX CABLE				_
HYBRID CABLE	¥0 (0.56			_
INTERIOR GROUND LINE		— G—	G	_
EXTERIOR GROUND LINE				_
PROPERTY LEASE LINE				-
PROPERTY LEASE LINE				-

GROUNDING SYMBOLS

IRREVERSIBLE CONNECTION

EXOTHERMIC

MECHANICAL CONNECTION

COPPER GROUND ROD

CHEM ROD

GROUND ROD TEST—WELL

12"/20" GROUND BAR



PE RENEWAL DATE DECEMBER 31, 2017





KGI WIRELESS, INC. 805 LAS CIMAS PKWY BUILDING THREE, SUITE 370 AUSTIN, TX 78746

TEL: 512.345.9595 FAX: 512.345.9898

SITE NAME:

LSC MCNUTT

LOCATION CODE:

300209

SITE ADDRESS: 100 AIRPORT ROAD SANTA TERESA, NM 88008

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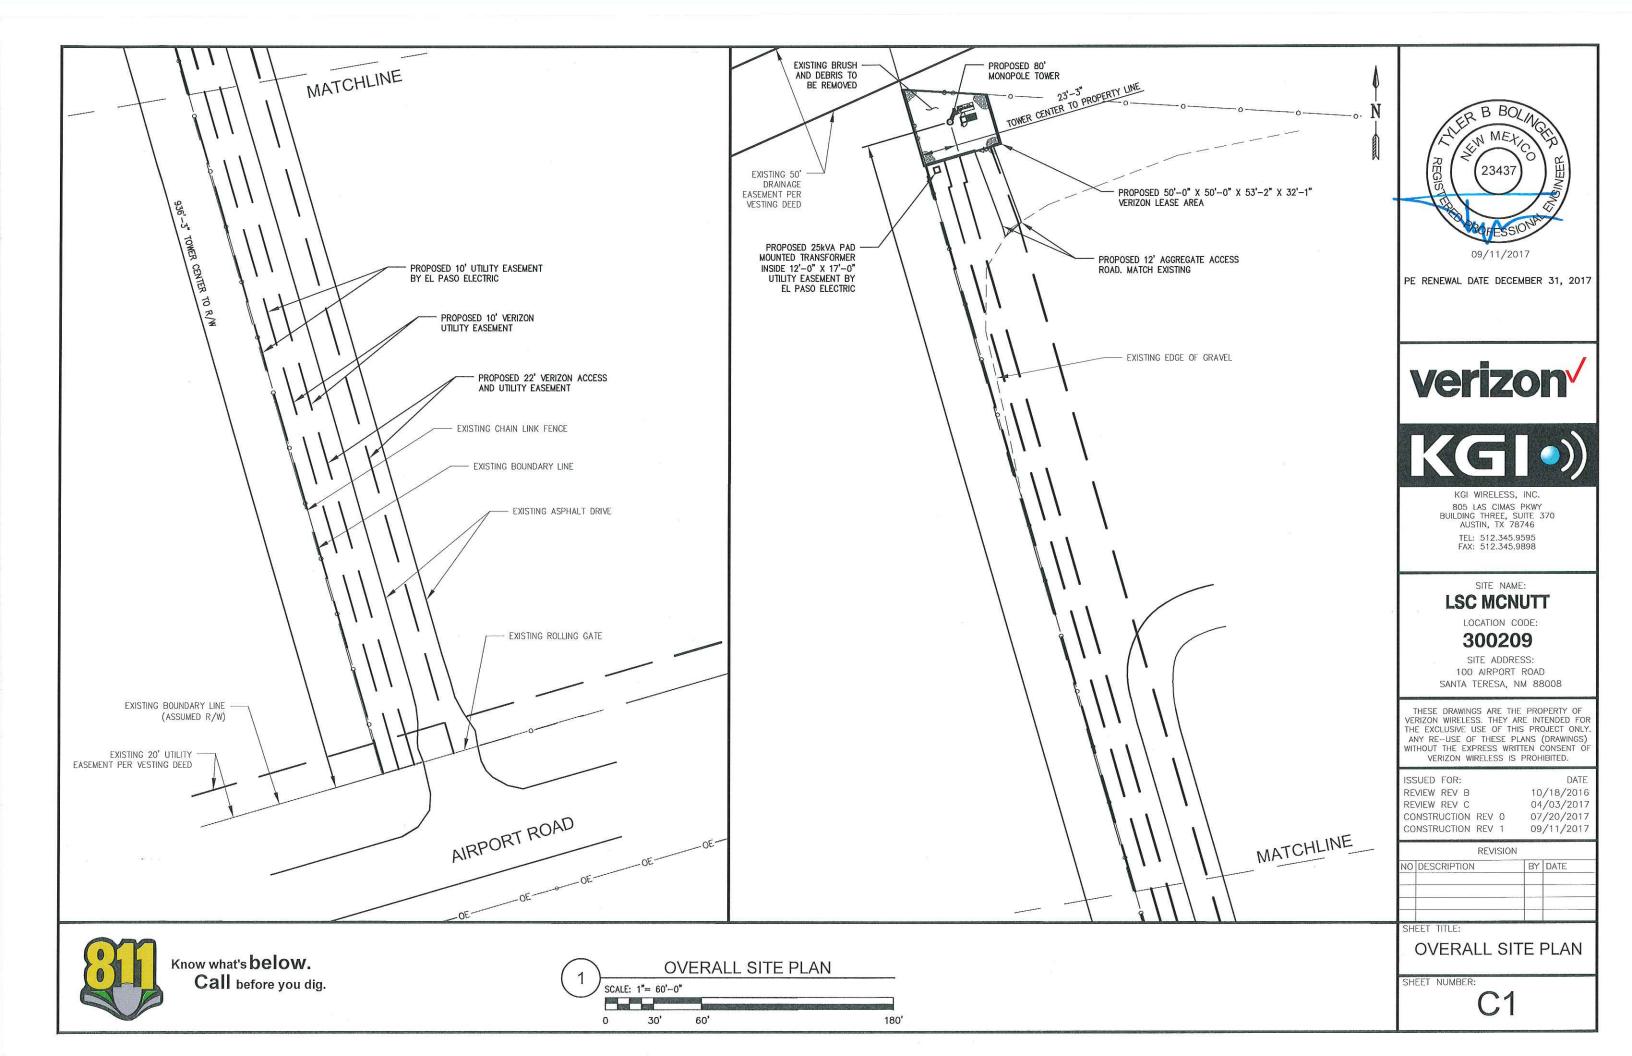
١	ISSUED FOR:			DATE
١	REVIEW REV B			10/18/2016
١	REVIEW REV C			04/03/2017
١	CONSTRUCTION	REV	0	07/20/2017
	CONSTRUCTION	REV	1	09/11/2017
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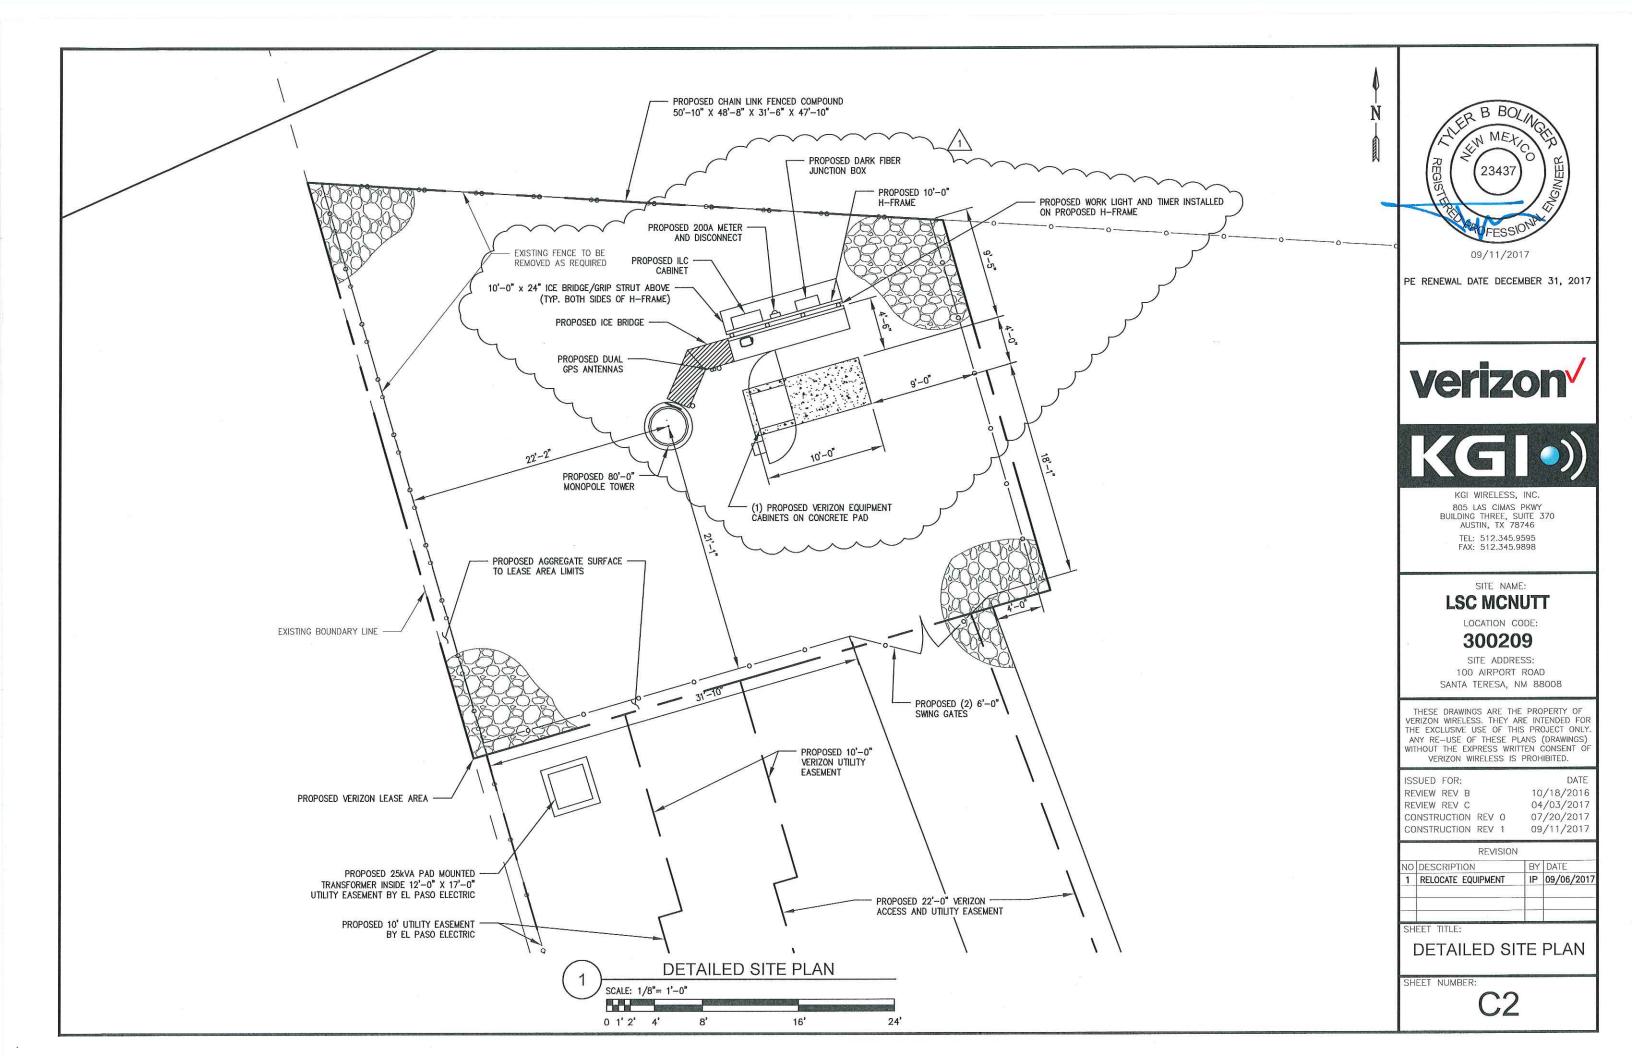
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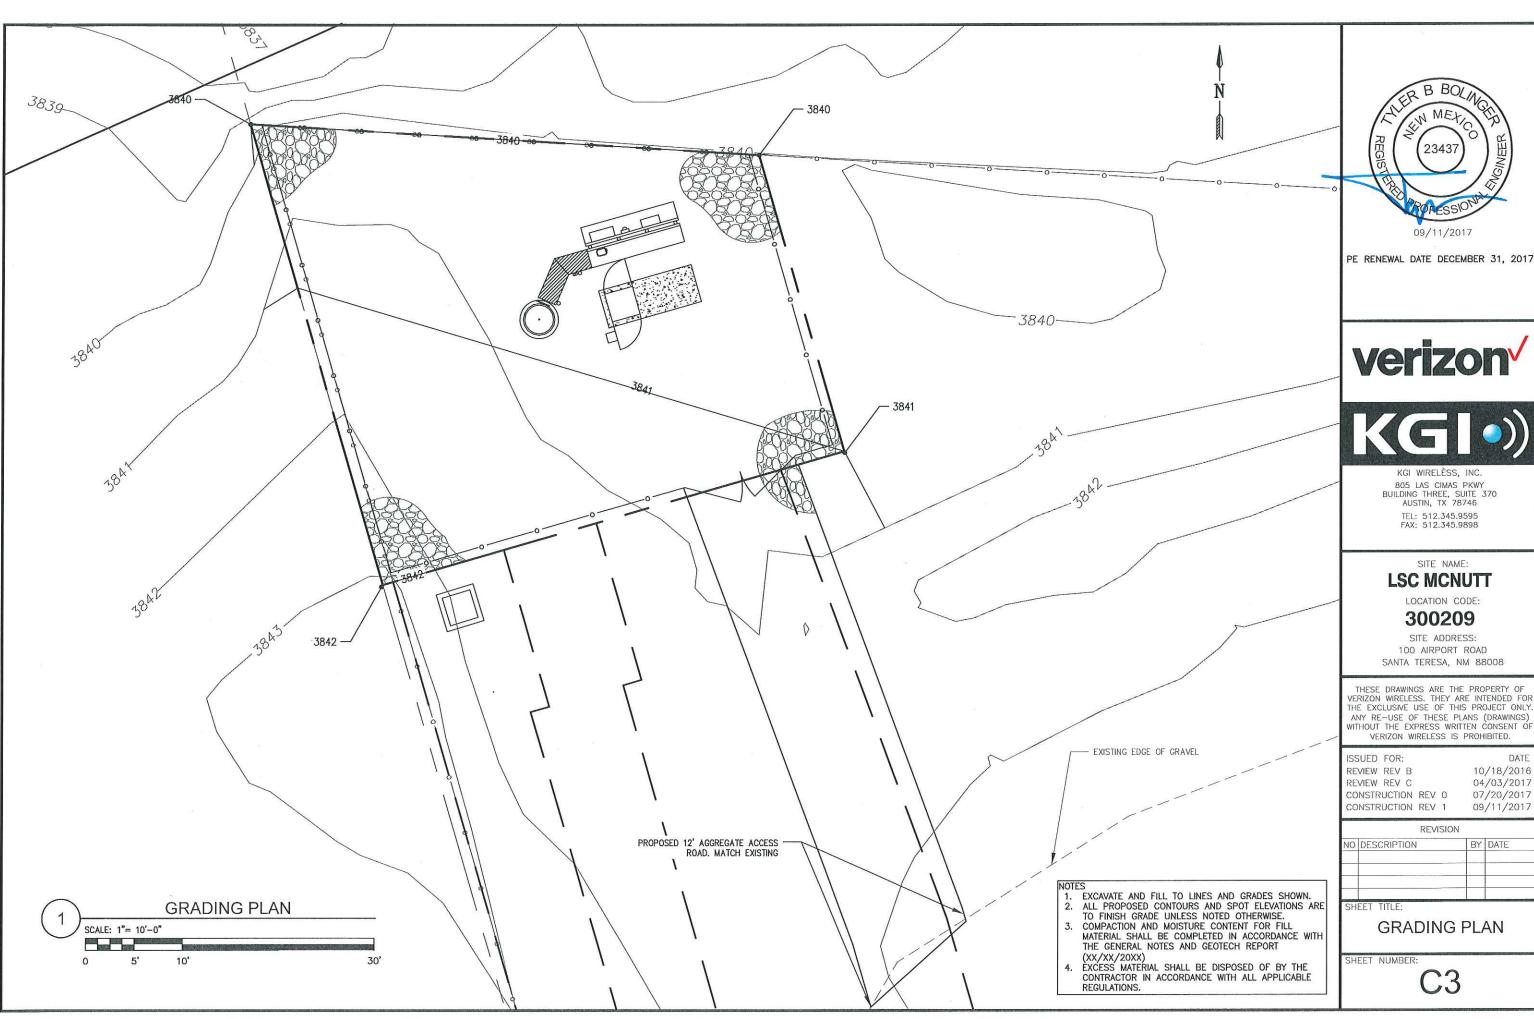
ABBREVIATIONS AND SYMBOLS

SHEET NUMBER:

GN1











805 LAS CIMAS PKWY BUILDING THREE, SUITE 370 AUSTIN, TX 78746


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10/18/2016 04/03/2017 07/20/2017 09/11/2017

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GRADING PLAN





09/11/2017

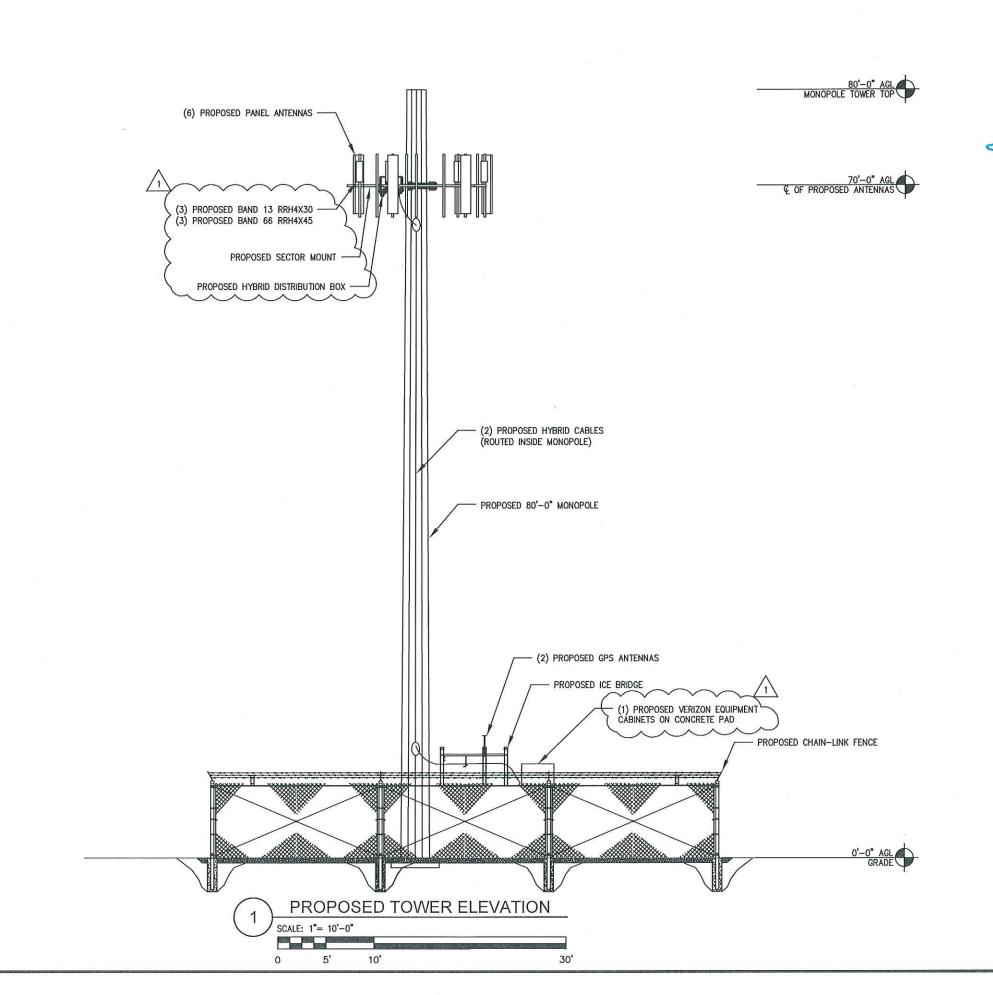PE RENEWAL DATE DECEMBER 31, 2017





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BUILDING THREE, SUITE 370
AUSTIN, TX 78746

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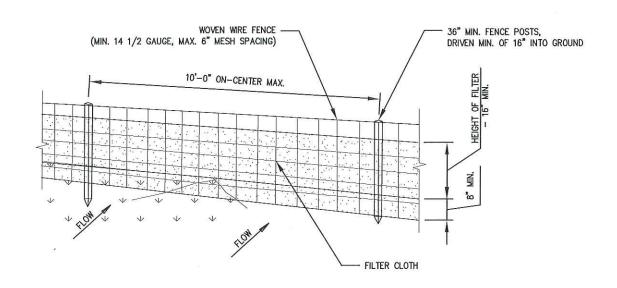
| ISSUED FOR: DATE | REVIEW REV B | 10/18/2016 | REVIEW REV C | 04/03/2017 | CONSTRUCTION REV 0 | 07/20/2017 | CONSTRUCTION REV 1 | 09/11/2017


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SHEET TITLE:

TOWER ELEVATION

SHEET NUMBER:



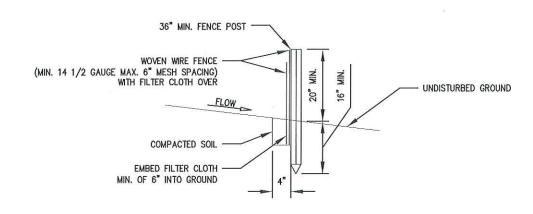

HARDWOOD FENCE: FILTER CLOTH:

STEEL EITHER "T" OR "U" TYPE OR 2"

WOVEN WIRE, 14 1/2 GA., 6" MAX. MESH OPENING FILTER X, MIRAFI 100X, STABILINKA T140N


OR APPROVED EQUAL.

PREFABRICATED UNIT: GEOFAB, ENVIROFENCE, OR APPROVED EQUAL.

CONSTRUCTION NOTES FOR FABRICATED SILT FENCE


- WOVEN WIRE FENCE TO BE FASTENED SECURELY TO FENCE POSTS WITH WIRE TIES OR STAPLES.
 2. FILTER CLOTH TO BE FASTENED SECURELY TO WOVEN WIRE FENCE WITH
- TIES SPACED EVERY 24" AT TOP AND MID SECTION.
- 3. WHEN TWO SECTIONS OF FILTER CLOTH ADJOIN EACH OTHER THEY SHALL BE OVERLAPPED BY 6" AND FOLDED.
- 4. MAINTENANCE SHALL BE PERFORMED AS NEED AND MATERIAL REMOVED WHEN "BULGES" DEVELOP IN THE SILT FENCE.

SILT FENCE DETAIL SCALE: N.T.S.

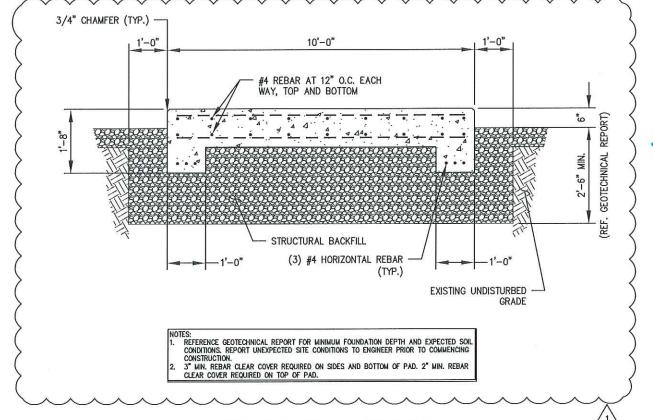

PROPOSED EQUIPMENT PAD SECTION

SCALE: N.T.S.

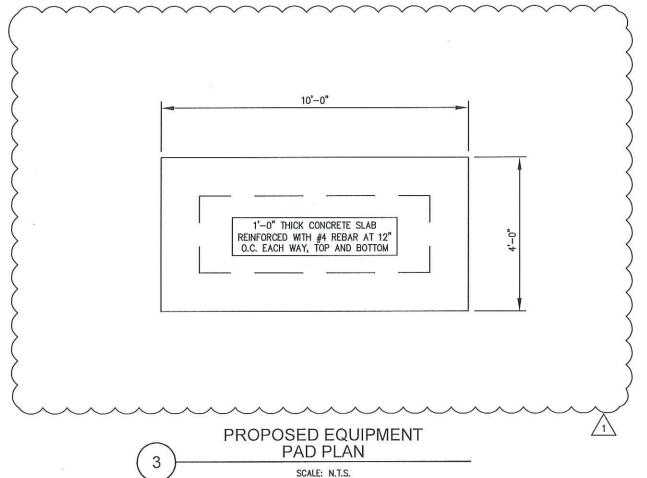



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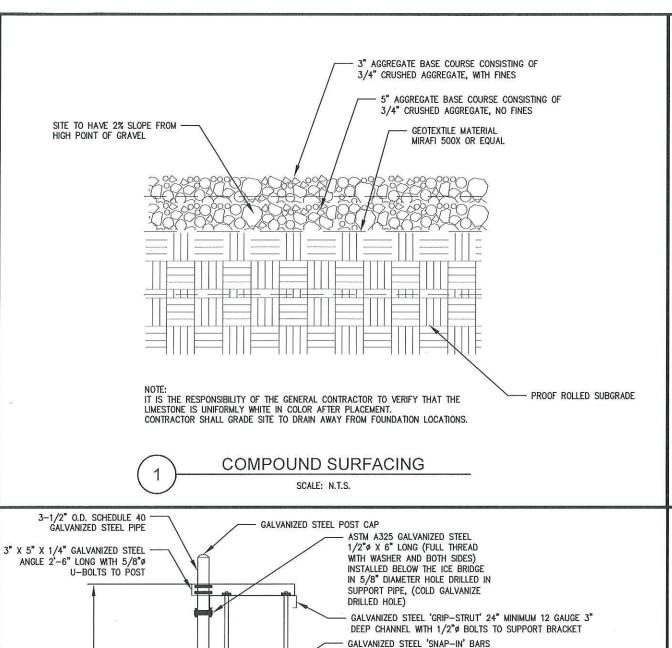
ISSUED FOR: 10/18/2016 REVIEW REV B REVIEW REV C 04/03/2017 07/20/2017 CONSTRUCTION REV 0 CONSTRUCTION REV 1 09/11/2017

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DAAAAA

'n

SERRESERES

1'-6"

3'-0" O.C. SUSPENDED WITH 3/8"Ø GALVANIZED STEEL ALL THREAD ROD

BETWEEN THE END POSTS.

ANTENNA CABLES

CONCRETE PIER FOOTING. (4) #4


GRADE 60 REBAR WITH 12" CIRCLE TIES AT 12" ON CENTER, CONCRETE


TO BE 4000 PSI AT 28 DAYS WITH 6%(±1%) ENTRAINED AIR

TYP. ICE BRIDGE SECTION


SCALE: N.T.S.

6" CRUSHED STONE

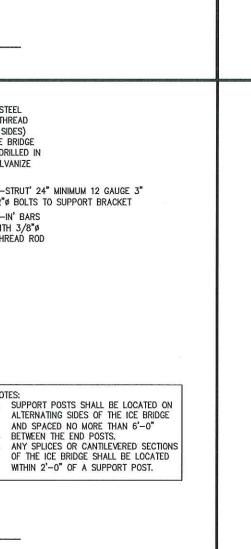


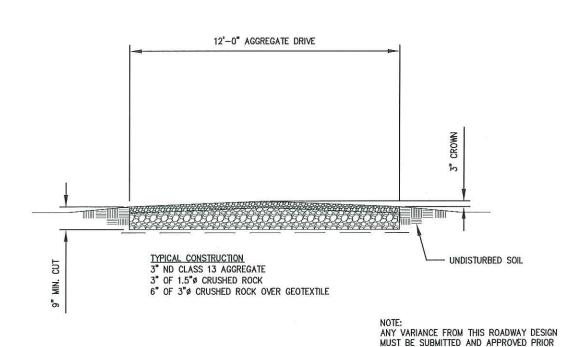

ACCESS DRIVE SECTION SCALE: N.T.S.

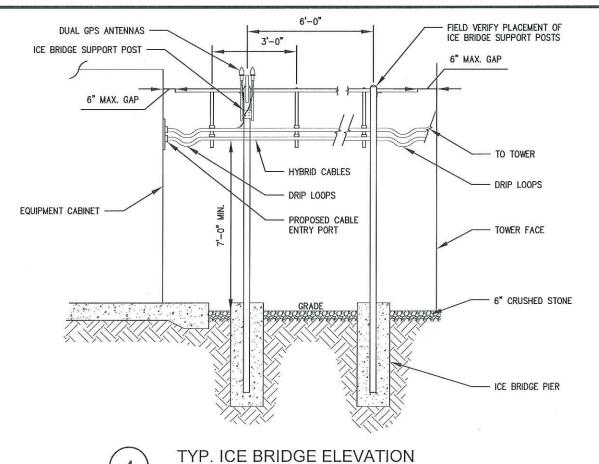

SCALE: N.T.S.

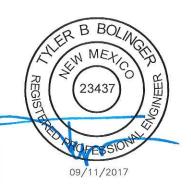

PE RENEWAL DATE DECEMBER 31, 2017





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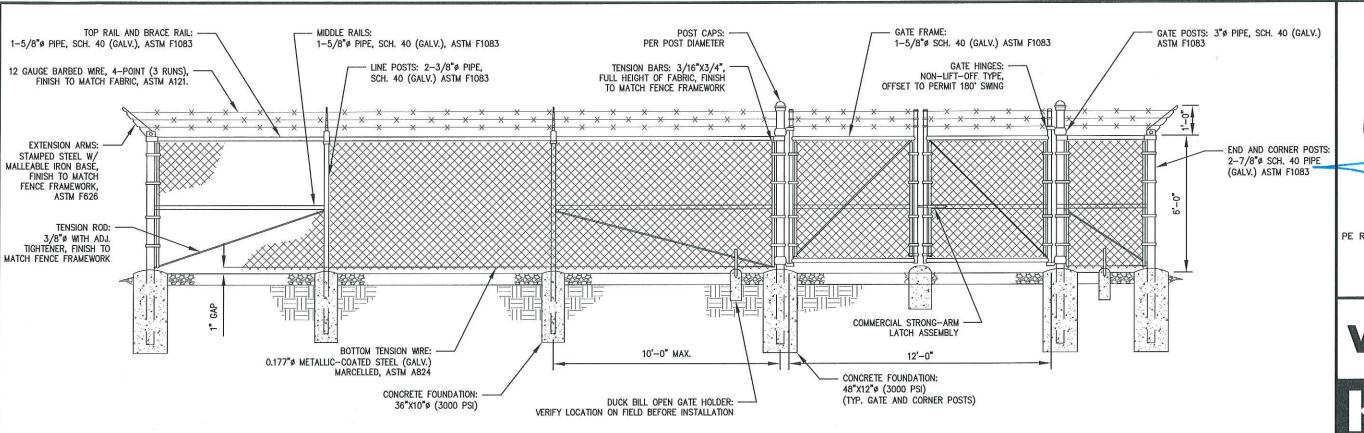
DATE ISSUED FOR: REVIEW REV B 10/18/2016 04/03/2017 REVIEW REV C CONSTRUCTION REV 0 07/20/2017 CONSTRUCTION REV 1 09/11/2017

DEVICION

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NOTES:

1. REFER TO PROJECT SPECIFICATIONS FOR INFORMATION NOT SHOWN IN THE DRAWING.

FENCE FABRIC SHALL CONFORM TO CHAIN LINK FENCE MANUFACTURERS INSTITUTE (CLFMI)
PRODUCT MANUAL.

3. INSTALL FENCE IN COMPLIANCE WITH ASTM F 567.

4. INSTALL SWING GATES IN COMPLIANCE WITH ASTM F 900.

5. DO NOT BEGIN INSTALLATION AND ERECTION BEFORE FINAL GRADING IS COMPLETED, UNLESS OTHERWISE PERMITTED. INSTALL FENCING ON BOUNDARY LINES INSIDE OF PROPERTY LINE ESTABLISHED BY SURVEY.


6. DRILL OR HAND-EXCAVATE (USING POST-HOLE DIGGER) HOLES FOR POST TO DIAMETERS AND SPACINGS INDICATED, IN FIRM, UNDISTURBED OR COMPACTED SOIL. IF NOT INDICATED ON DRAWINGS, EXCAVATE HOLES FOR EACH POST TO MINIMUM DIAMETER RECOMMENDED BY FENCE MANUFACTURER, BUT NOT LESS THAN (4) TIMES LARGEST CROSS-SECTION OF POST.

 REMOVE POST HOLE SPOILS FROM SITE. DO NOT SET SPOILS ON AGGREGATE WITHOUT ADEQUATE PROTECTION.


8. PROTECT PORTION OF POST ABOVE GROUND FROM CONCRETE SPLATTER. PLACE CONCRETE AROUND POSTS AND VIBRATE OR TAMP FOR CONSOLIDATION. CHECK EACH POST FOR VERTICAL AND TOP ALIGNMENT AND HOLD IN POSITION DURING PLACEMENT AND FINISHING OPERATIONS, UNLESS OTHERWISE SHOWN, EXTEND CONCRETE FOOTING 1 INCH ABOVE GRADE AND TROWEL TO A CROWN TO SHED WATER.


9. INSTALL BARBED WIRE IN ACCORDANCE WITH MANUFACTURERS INSTRUCTIONS.

10. APPLY FABRIC TO OUTSIDE OF FRAMEWORK.

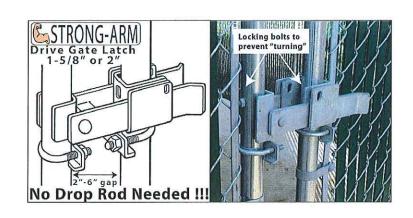



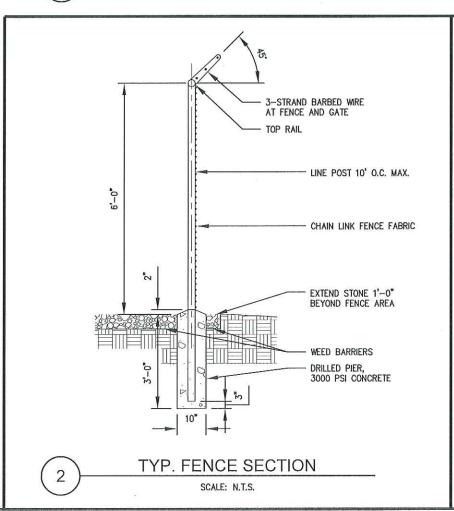

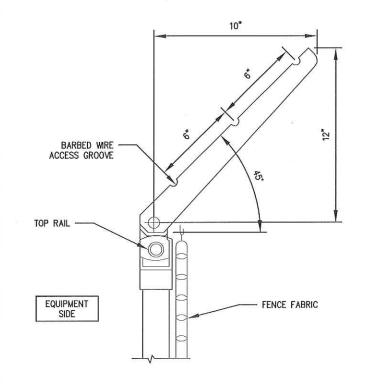

TYP. BARBED WIRE DETAIL

SCALE: N.T.S.



PE RENEWAL DATE DECEMBER 31, 2017





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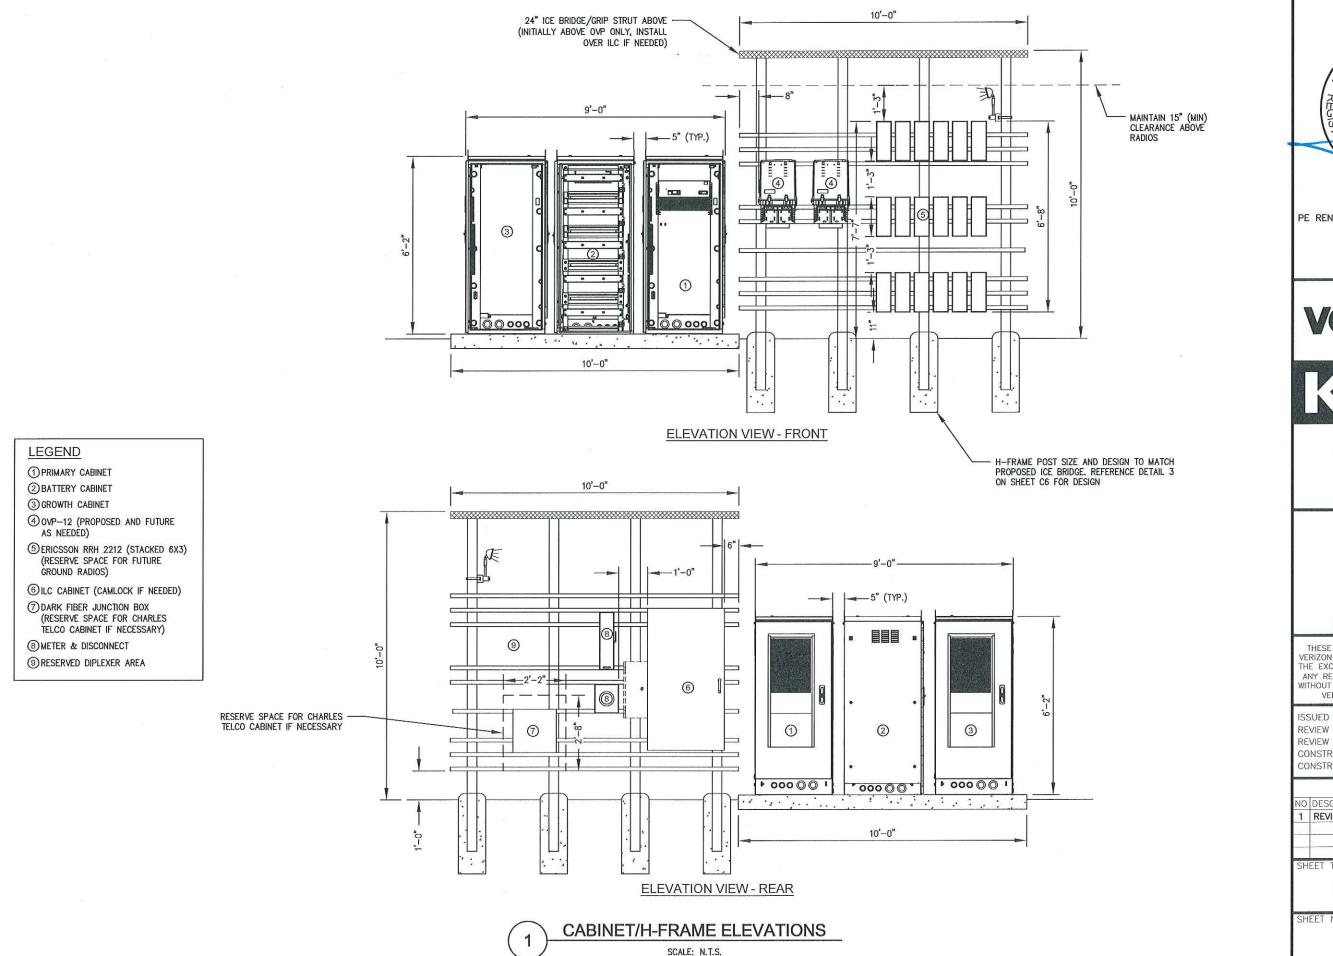
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CONSTRUCTION	REV	0	07/20/2017
CONSTRUCTION	REV	1	09/11/2017

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PE RENEWAL DATE DECEMBER 31, 2017





805 LAS CIMAS PKWY BUILDING THREE, SUITE 370 AUSTIN, TX 78746

TEL: 512.345.9595 FAX: 512.345.9898

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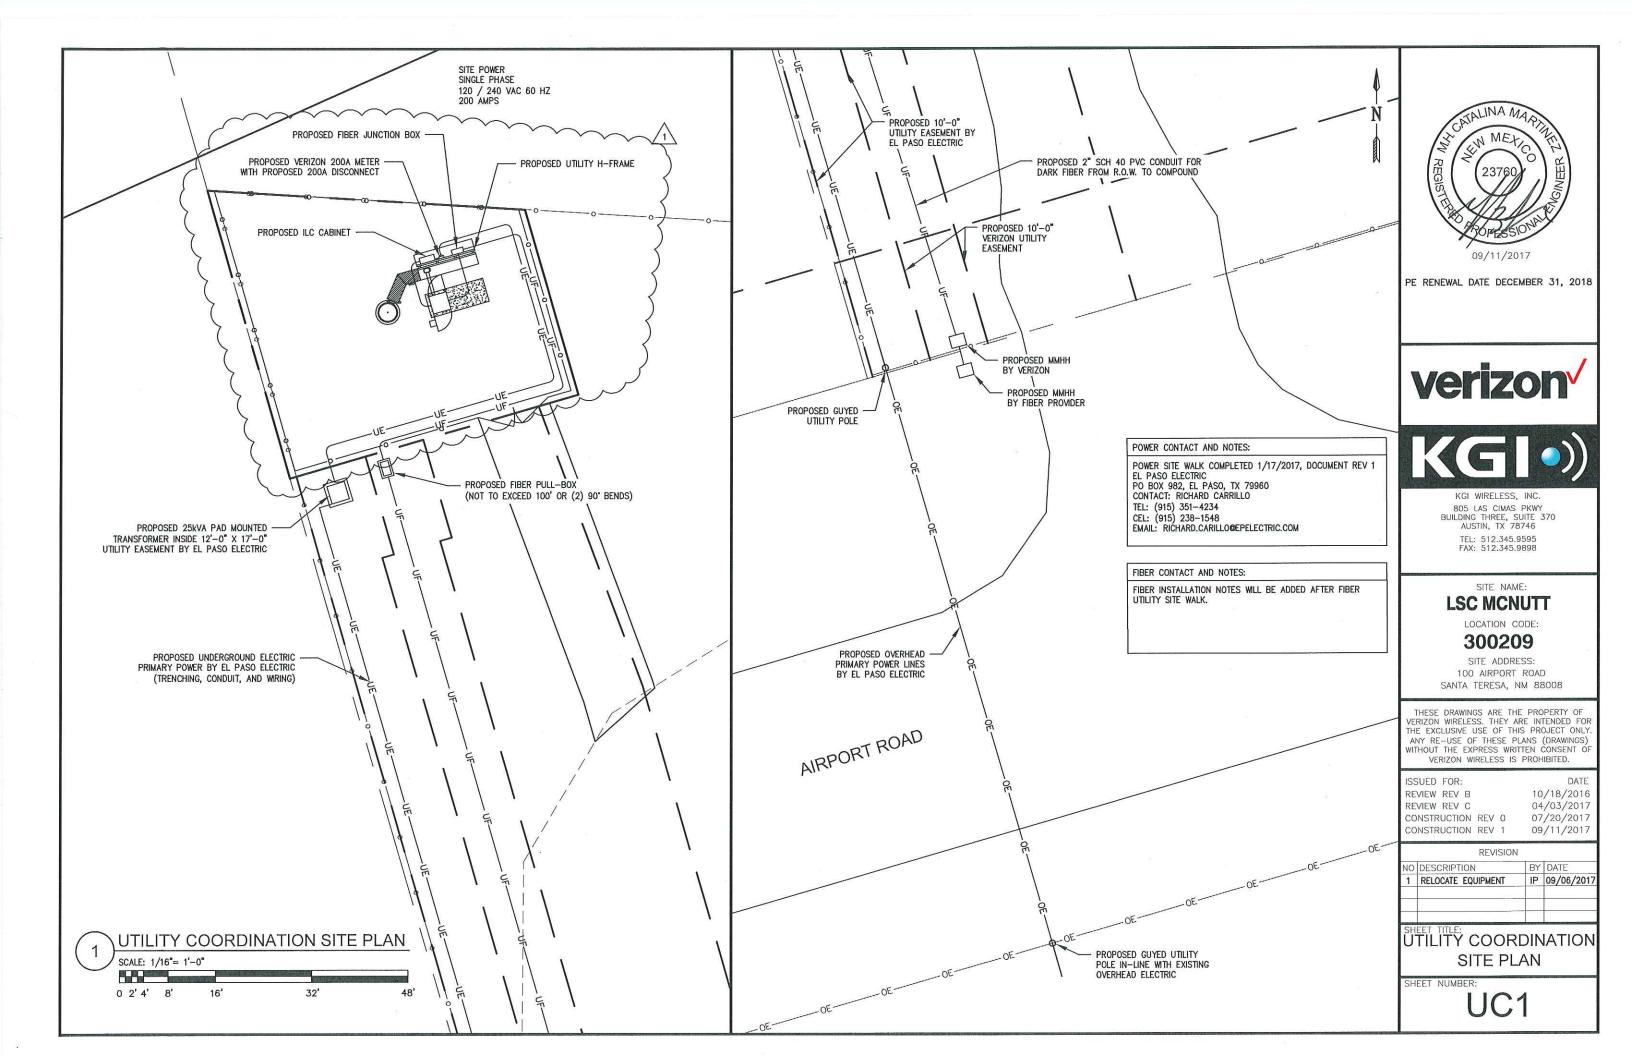
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REVIEW REV C		04/03/201
CONSTRUCTION	REV 0	07/20/201
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NO	DESCRIPTION	BY	DATE
1	REVISED SHEET	IP	09/11/2017
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SHEET TITLE:

CIVIL DETAILS

SHEET NUMBER:



GENERAL GROUNDING NOTES:

- CONTRACTOR SHALL COMPLY WITH UTILITIES ELECTRICAL SERVICE SPECIFICATIONS, OBTAIN A COPY AS NEFDED.
- THE ELECTRICAL INSTALLATION WORK SHALL COMPLY WITH ALL LOCAL, STATE AND NATIONAL CODES, LAWS AND ORDINANCES APPLICABLE TO ELECTRICAL WORK.
- 3. ARC FLASH HAZARD WARNING SIGNS
 PER NEC ARTICLE 110.16, EACH OF THE FOLLOWING DEVICES SHALL HAVE A PERMANENT LABEL OR
 SIGN AFFIXED WARNING QUALIFIED PERSONS OF POTENTIAL ARC FLASH HAZARDS: SERVICE
 GUTTER—BOXES, METER ENCLOSURES, DISCONNECTS, TRANSFORMERS, DOWN-STREAM OR SERVICE
 EQUIPMENT, TRANSFER SWITCHES, DISTRIBUTION PANEL BOARDS, ANY OTHER DEVICES THAT ARE
 INSTALLED AND ARE SPECIFIED IN NEC ARTICLE 110.16. THIS LABEL OR SIGN SHALL MEET THE
 GUIDELINES FOR SAFETY SIGNS SPECIFIED IN THE CURRENT REVISION OF ANSI Z535.4
- 4. CONTRACTOR SHALL VISIT SITE AND VERIFY EXISTING CONDITIONS BEFORE BEGINNING WORK.
- 5. ALL MATERIAL AND EQUIPMENT FURNISHED AND INSTALLED UNDER THIS CONTRACT SHALL BE NEW, FREE FROM DEFECTS, AND SHALL BE GUARANTEED FOR A PERIOD OF ONE YEAR FROM THE DATE OF FINAL ACCEPTANCE BY OWNER OR HIS REPRESENTATIVE. SHOULD ANY TROUBLE DEVELOP DURING THIS PERIOD DUE TO FAULTY WORKMANSHIP, MATERIAL OR EQUIPMENT, THE CONTRACTOR SHALL FURNISH ALL NECESSARY MATERIALS AND LABOR TO CORRECT THE TROUBLE WITHOUT COST TO THE OWNER.
- ALL WORK TO BE EXECUTED IN A WORKMANLIKE MANNER AND SHALL PRESENT A NEAT MECHANICAL APPEARANCE WHEN COMPLETED.
- CONTRACTOR SHALL BE RESPONSIBLE FOR FOR ALL CUTTING AND PATCHING RELATED TO ELECTRICAL WORK.
- ALL BRANCH CIRCUIT CONDUCTORS SHALL BE COPPER TYPE "TH". #12, AND #10 SOLID, #8 AND LARGER STRANDED.
- 9. CONTRACTOR SHALL FURNISH AS-BUILT DRAWINGS TO THE VERIZON WIRELESS PROJECT MANAGER UPON COMPLETION OF THE JOB.
- 10. ELECTRICAL WORK SHALL INCLUDE ALL LABOR, MATERIALS AND EQUIPMENT REQUIRED, INCLUDING, BUT NOT LIMITED TO, COMPLETE ELECTRICAL SYSTEMS, POWER AND LIGHTING, TELEPHONE CONDUIT SYSTEM, SIGNAL SYSTEMS, PANEL BOARDS, CONTROL WIRING, GROUNDING, CONDUIT ONLY SYSTEMS, ETC., AS INDICATED ON ELECTRICAL DRAWINGS AND/OR REQUIRED BY GOVERNING CODES.
- 11. PRIOR TO INSTALLING ANY ELECTRICAL WORK, THE CONTRACTOR SHALL VERIFY THE EXACT LOCATIONS AND REQUIREMENTS ON THE JOB, AND BY REFERENCE TO ARCHITECTURE, AND EQUIPMENT SUPPLIERS DRAWINGS. SHOULD THERE BE ANY QUESTIONS OR PROBLEMS CONCERNING THE NECESSARY PROVISIONS TO BE MADE, PROPER DIRECTIONS FROM THE VERIZON WIRELESS PROJECT MANAGER SHALL BE OBTAINED BEFORE PROCEEDING WITH ANY WORK.
- 12. THE CONTRACTOR SHALL VERIFY EXISTING SITE CONDITIONS, ELECTRICAL SERVICE REQUIREMENTS AND COORDINATE ALL INTERCONNECTION REQUIREMENTS WITH LOCAL UTILITY AS NECESSARY.
- 13. THE NOTE, SPECIFICATION OR CODE WHICH PRESCRIBES AND ESTABLISHES THE HIGHEST STANDARD OF PERFORMANCE SHALL PREVAIL IN THE EVENT OF ANY CONFLICT OR INCONSISTENCY BETWEEN ITEMS SHOWN ON THE PLANS AND/OR SPECIFICATIONS.
- 14. THE CONTRACTOR SHALL FURNISH AND PAY FOR ALL PERMITS AND RELATED FEES.
- 15. THE CONSTRACTOR SHALL BE RESPONSIBLE FOR CONFORMANCE WITH THE NATIONAL ELECTRICAL CODE, STATE OF TEXAS ELECTRICAL SAFETY ORDERS, ALL CODES AND ORDINANCES AND ALL OTHER ADMINISTRATIVE AUTHORITIES HAVING JURID=SDICTION OVER THIS WORK.

GENERAL GROUNDING NOTES:

- CONTRACTOR TO COMPLY WITH VERIZON WRELESS CELL SITE GROUNDING & BONDING SPECIFICATIONS. IN THE EVENT THAT DRAWINGS CONFLICT WITH VERIZON WRELESS SPECIFICATIONS, VERIZON WRELESS SPECIFICATIONS SHALL GOVERN.
- ALL DETAILS ARE SHOWN IN GENERAL TERMS, ACTUAL GROUNDING INSTALLATION AND MOUNTING MAY VARY DUE TO SITE SPECIFIC CONDITIONS, XIT GROUND MAY BE REQUIRED.
- 3. GROUND RODS SHALL BE COPPER CLAD STEEL, 5/8" X 8'-0" LONG.
- 4. INSTALL GROUND AND BONDING CONDUCTORS WITH SUFFICIENT SLACK TO AVOID BREAKING DUE TO SETTLEMENT AND MOVEMENT OF CONDUCTORS AT ATTACHED POINTS.
- 5. RESISTANCE TO GROUND SHALL NOT EXCEED 5 OHMS MEASUREMENT. ADDITIONAL GROUND RODS OR XIT GROUND SHALL BE PROVIDED TO ATTAIN THIS VALUE OR LESS. WHERE MULTIPLE RODS ARE INSTALLED, THEY SHALL BE SPACED BETWEEN 8 AND 16 FEET APART.
- 6. ALL GROUNDING CONDUCTORS SHALL BE U.L. LISTED FOR THEIR PURPOSE.
- ALL GROUND CONNECTIONS TO GROUND BARS SHALL BE U.L. 467 LISTED, IRREVERSIBLE COMPRESSION TYPE.
- 8. ALL CONNECTIONS TO GROUND BARS SHALL BE COATED WITH ANTIOXIDANT COMPOUND.
- 9. PROVIDE ONE-TIME HIT 11b HAMMER TEST ON ALL CADWELDS.
- 10. ALL EXTERIOR GROUND BARS SHALL BE GALVANIZED STEEL

ELECTRICAL AND GROUNDING NOTES

GROUNDING I



PE RENEWAL DATE DECEMBER 31, 2018





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ONSTRUCTION	REV	1	09/11/2017
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NO DESCRI	IPTION	BY	DATE

ELECTRICAL AND
GROUNDING NOTES

SHEET NUMBER:

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LOAD CAL	CULATION
LOAD	AMPS
PROPOSED LOAD:	176.0
TOTAL DEMAND:	176.0

VOLTAGE: 120/240V SINGLE PHASE 3W 200A

MODEL VZW ILC ASCO D300L SERIES NUMBER: 1 3 240 120 VOLTS PHASE/WIRE: VOLTAGE: BUS RATING: KEY DOOR LATCH: 200 AMPS 200 BREAKER: NEUTRAL BAR: HENGED DOOR: MOUNT: SURFACE YES ENCOLSURE NEMA 3R AIC: 65K BUS AMPS USAGE POS FACTOR POLES AMPS AMPS POLES LOAD LOAD L1 L2 L1 L2 18 **FUTURE** RECTIFIER RECTIFIER 18 18 FUTURE RECTIFIER RECTIFIER 18 18 **FUTURE** RECTIFIER RECTIFIER

18

18

16

RECTIFIER

GFI RECEPT./LIGHT

BLOCK HEATER

BATT. CHARGER

88 :SUB TOTAL AMPS

ALL CONDUCTORS ARE TYPE THWN (75°C) COPPER.
MAXIMUM LENGTH OF RUN FOR RECTIFIER CIRCUITS IS 50FT.

ASCO INTEGRATED LOAD CENTER INCLUDES 200 AMP MAIN DISCONNECT

AND TRANSFER SWITCH FOR PORTABLE OR PERMANENT GENERATOR.

18

16

16

17

19

23

25

27

29

YES

YES

11

18

18

18

72

176

FUTURE

RECTIFIER

SUB TOTAL AMPS:

FACTORED TOTAL

BUS AMPS

L2

18

18

18

72

USAGE

FACTOR

6

8

10

12

14

16

18

20


22

24

26

28

30

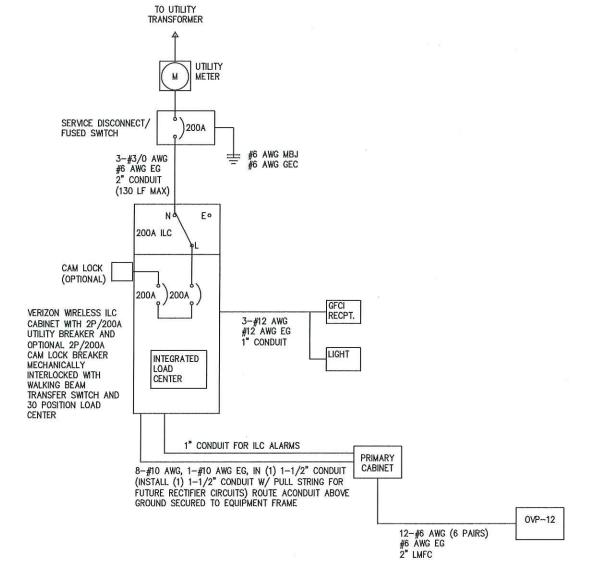

RECTIFIER LOADS ARE CONSIDERED TO BE NON-CONTINUOUS. PANEL SCHEDULE 2

(1) 2" GRC STRAIGHT RUN AT GRADE (CLAMP TO EQUIPMENT (1) 2" CONDUIT VZW EQUIPMENT FRAME FRAME POSTS), TRANSITION TO 2" (FOR DARK FIBER TERMINATION POINT LMFC AT EACH FOR EQUIPMENT OR EBH AS NEEDED) CABINET CONNECTIONS 18"X18" FIBER JUNCTION BOX FOR DARK FIBER OR CHARLES CABINET AS NEEDED FOR EBH) (1) 2" CONDUIT FOR DARK FIBER * PRIMARY CABINET AND (1) 2" CONDUIT VZW FIBER HANDHOLE FIBER HANDHOLE/ FOR EBH IF NEEDED ** (OR JUNCTION BOX ON 2" LMFC FOR MEET-ME POINT COMMON USE UTILITY FIBER AND ALARM AT ROW FRAME) IN COMPOUND (SHIELDED CAT 5) AS NEEDED FIBER HANDHOLE/ 0VP-12 MEET-ME POINT (1) 2" CONDUIT AT ROW (FOR EBH IF NEEDED) ADD (1) ADDITIONAL 2" CONDUIT FOR DARK FIBER (2 TOTAL) IF REQUIRED BY LOCAL MARKET FACILITIES.

SCALE: N.T.S.

ALL EQUIPMENT SHALL BE NEMA 3R RATED

ALL EQUIPMENT SHALL BE LIGHTNING PROTECTED IN ACCORDANCE WITH TIA-222-G AND VERIZON WIRELESS STANDARDS CONDUCTOR SIZES AND DISTANCES HAVE BEEN SIZED FOR 3% MAX VOLTAGE DROP (TOTAL SYSTEM VOLTAGE DROP ON BOTH

FEEDERS AND BRANCH CIRCUITS TO THE FARTHEST DEMAND SHALL NOT EXCEED 5%)

WIRE SIZING AND MAXIMUM DISTANCE FROM GENERATOR TO ILC ASSUMES POWER FACTOR OF 0.9 BELOW GRADE CONDUIT SHALL BE SCHEDULE 80 PVC. ABOVED GRADE CONDUIT SHALL BE GALVANIZED RIGID CONDUIT. BELOW GRADE PVC CONDUIT SHALL TRANSITION TO GRC PRIOR TO RISING ABOVE GRADE. ALL BENDS SHALL HAVE A MINIMUM 24" RADIUS, ALL FITTINGS SHALL BE SUITABLE FOR USE WITH THREADED RIGID CONDUIT, VERIFY CONDUIT TYPE WITH LOCAL CONSTRUCTION MANAGER AND ADJUST IF NECESSARY. ALL CONDUIT SHALL MEET NEC, STATE, AND LOCAL CODE REQUIREMENTS AS REQUIRED.

FIBER SINGLE LINE DIAGRAM (TYP.)

VERIFY PRIOR TO CONSTRUCTION (ADD 2 PULL STRINGS TO EACH CONDUIT)

VERIFY EBH REQUIREMENTS WITH TELCO PROVIDER PRIOR TO CONSTRUCTION

(ADD 2 PULL STRINGS TO EACH CONDUIT)

SCALE: N.T.S.

IN MET 23760

PE RENEWAL DATE DECEMBER 31, 2018





KGI WIRFLESS, INC. 805 LAS CIMAS PKWY BUILDING THREE, SUITE 370 AUSTIN, TX 78746

TEL: 512.345.9595 FAX: 512.345.9898

SITE NAME:

LSC MCNUTT

LOCATION CODE:

300209

SITE ADDRESS: 100 AIRPORT ROAD SANTA TERESA, NM 88008

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DATE ISSUED FOR: REVIEW REV B 10/18/2016 REVIEW REV C 04/03/2017 CONSTRUCTION REV 0 07/20/2017 CONSTRUCTION REV 1 09/11/2017


REVISION DESCRIPTION BY DATE REVISED SHEET IP 09/11/201


ONE-LINE DIAGRAM

SHEET NUMBER

ONE-LINE DIAGRAM

SCALE: N.T.S.

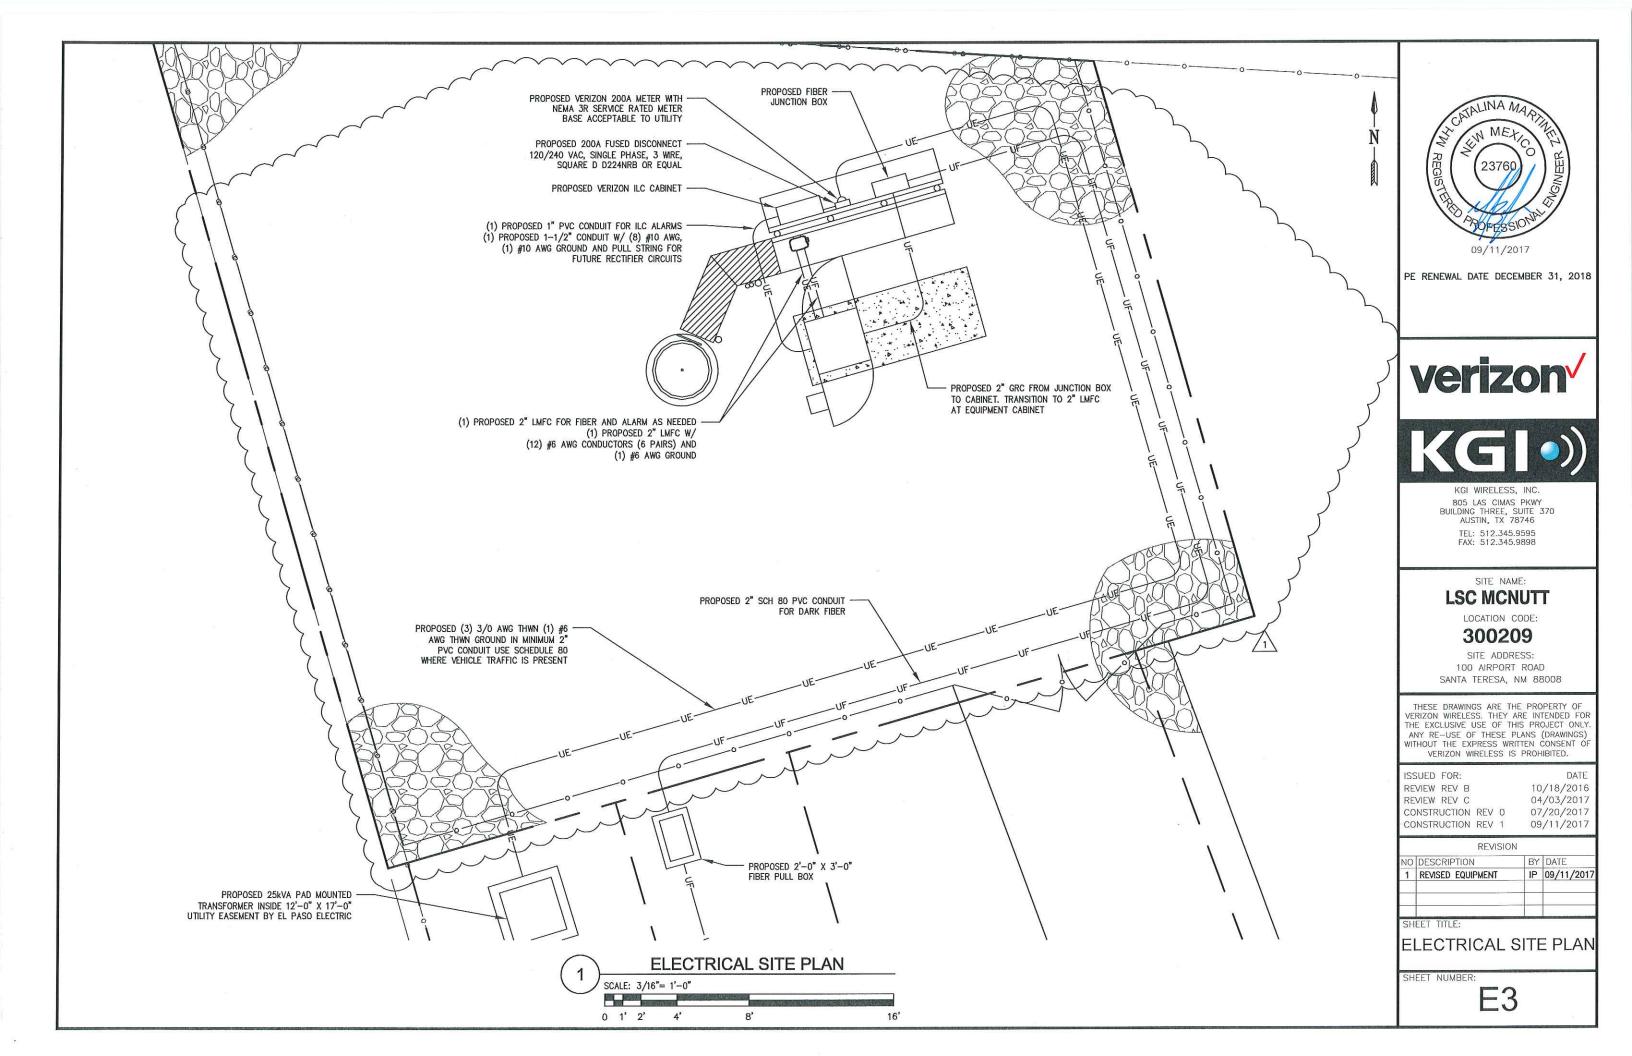

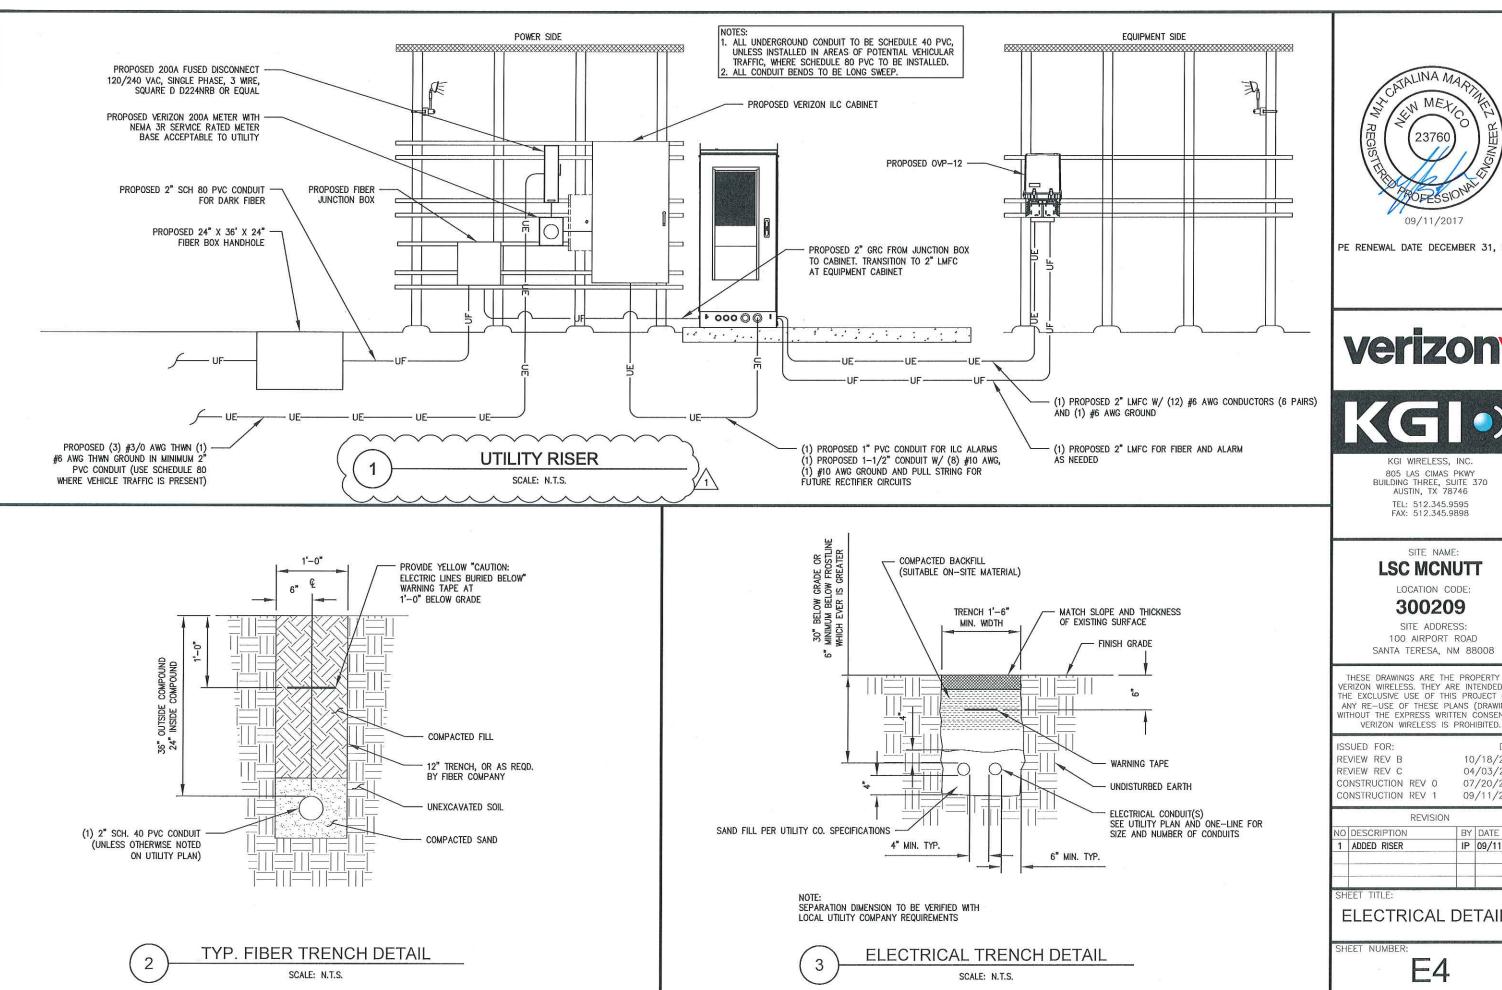



PE RENEWAL DATE DECEMBER 31, 2018





805 LAS CIMAS PKWY BUILDING THREE, SUITE 370 AUSTIN, TX 78746 TEL: 512.345.9595

SITE ADDRESS: 100 AIRPORT ROAD


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WITHOUT THE EXPRESS WRITTEN CONSENT OF

10/18/2016 04/03/2017 07/20/2017 09/11/2017

DATE

DESCRIPTION	BY	DATE
ADDED RISER	IP	09/11/2017

ELECTRICAL DETAILS

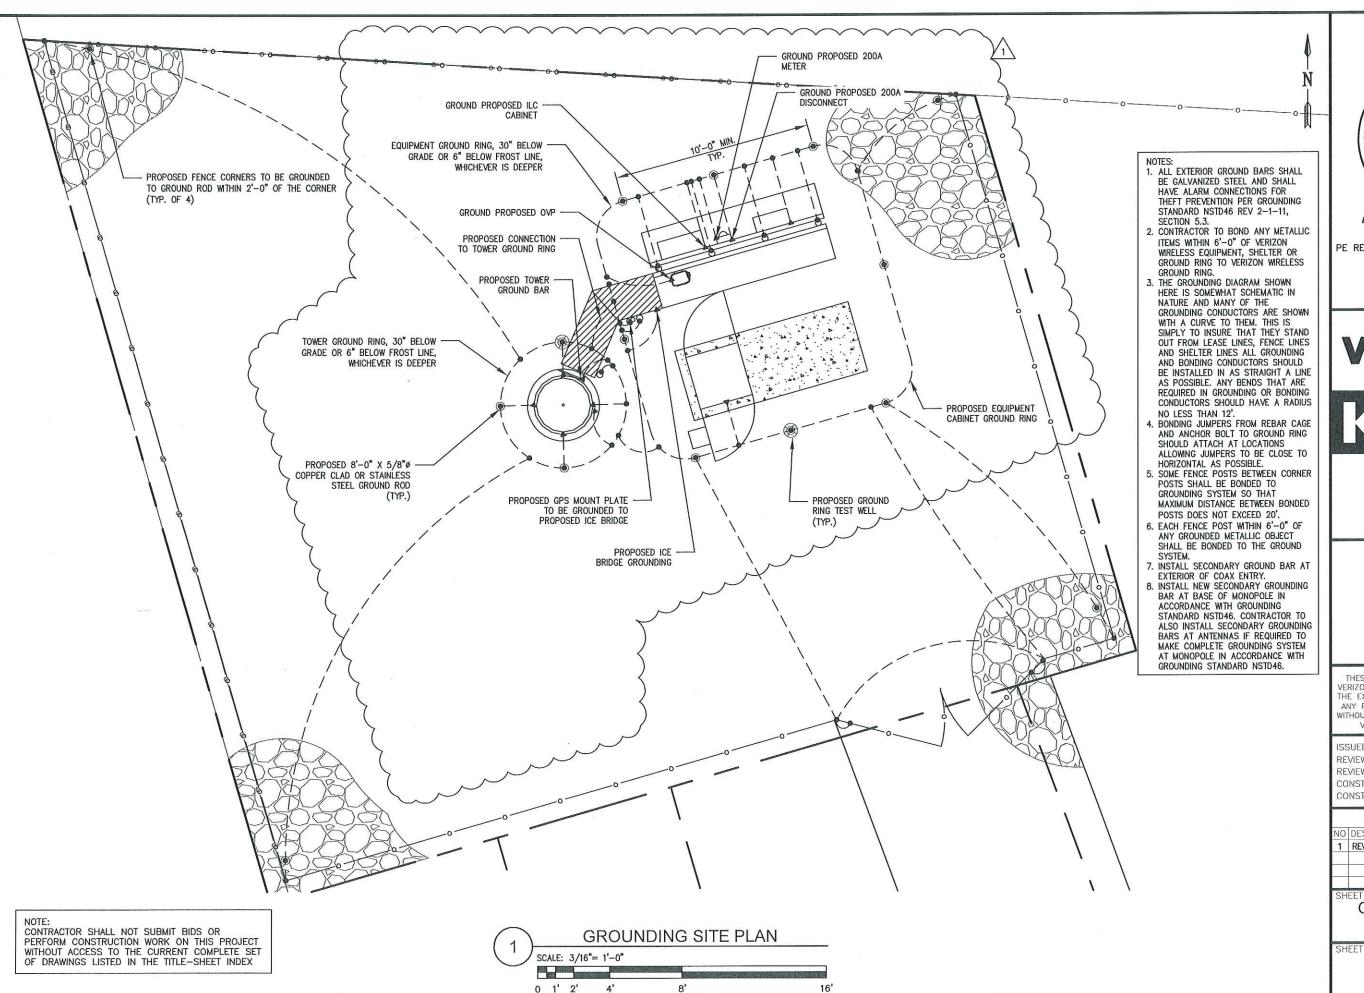



PE RENEWAL DATE DECEMBER 31, 2018





KGI WIRELESS, INC. 805 LAS CIMAS PKWY BUILDING THREE, SUITE 370 AUSTIN, TX 78746

TEL: 512.345.9595 FAX: 512.345.9898

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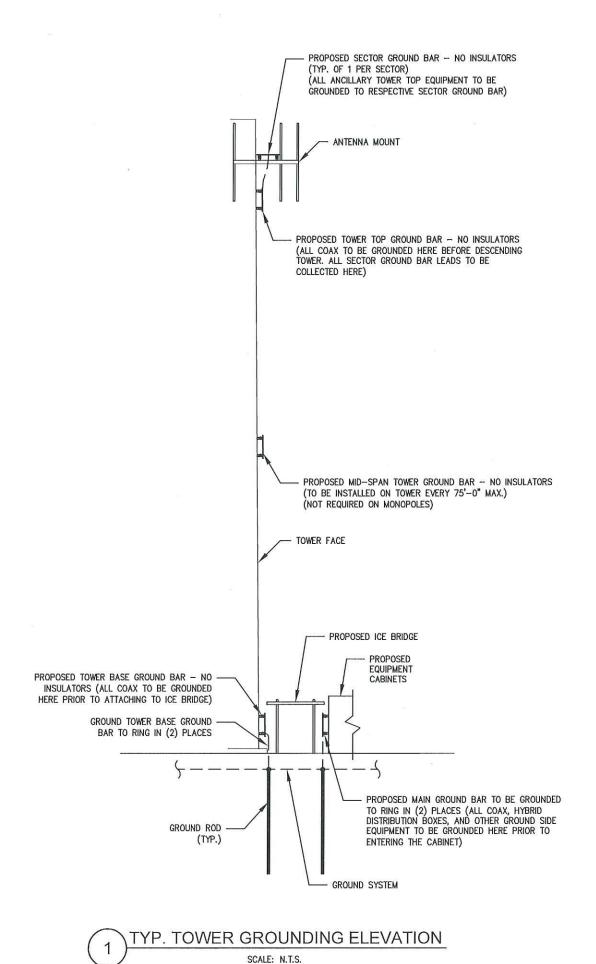
ISSUED FOR: DATE REVIEW REV B 10/18/2016 REVIEW REV C 04/03/2017 CONSTRUCTION REV 0 07/20/2017 CONSTRUCTION REV 1 09/11/2017

	REVISIO	N	
NO	DESCRIPTION	BY	DATE
1	REVISED EQUIPMENT	IP	09/06/2017
-		-	
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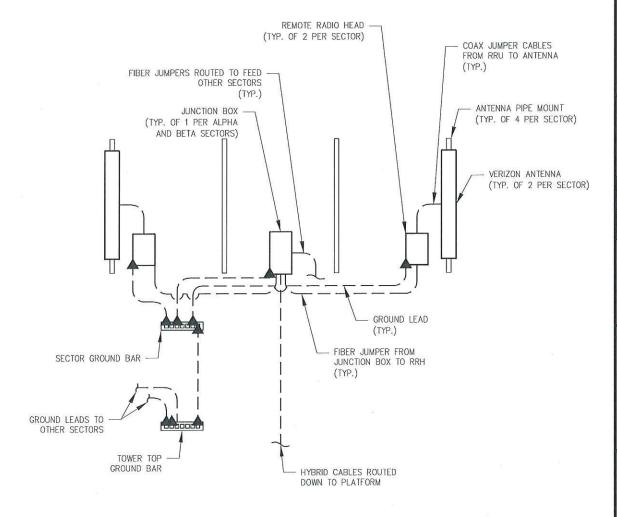
GROUNDING SITE PLAN

SHEET NUMBER:

G1



NOTE: GROUNDING DIAGRAM IS TYPICAL FOR ALL SECTORS EXCEPT WHERE NOTED.





PE RENEWAL DATE DECEMBER 31, 2018





KGI WIRELESS, INC. 805 LAS CIMAS PKWY BUILDING THREE, SUITE 370 AUSTIN, TX 78746

TEL: 512.345.9595 FAX: 512.345.9898

SITE NAME:

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LOCATION CODE:

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| ISSUED FOR: DATE | REVIEW REV B | 10/18/2016 | REVIEW REV C | 04/03/2017 | CONSTRUCTION REV 0 | 07/20/2017 | CONSTRUCTION REV 1 | 09/11/2017 | |

NO	DESCRIPTION	BY	DATE
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SHEET TITL

GROUNDING DETAILS


SHEET NUMBER:

G2

TYP. ANTENNA GROUNDING DIAGRAM


2

SCALE: N.T.S.

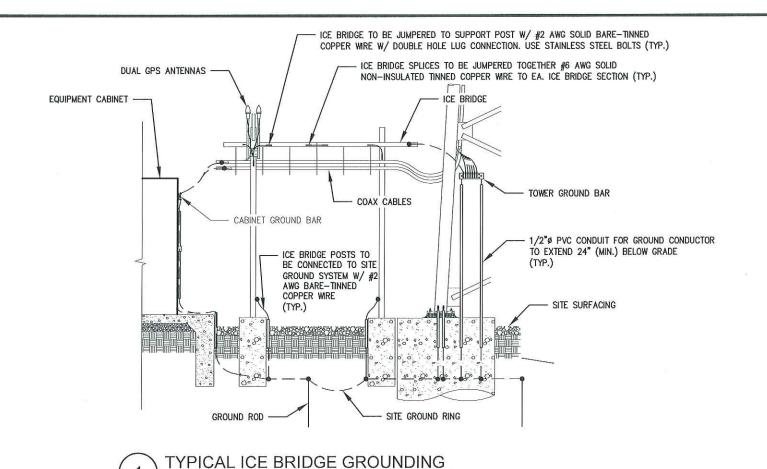

SCALE: N.T.S.

#2 AWG BARE COPPER CONDUCTOR BONDED BETWEEN HORIZONTAL AND VERTICAL POST (EXOTHERMIC WELD CONNECTIONS) (TYP.) EACH STRAND OF BARBED WIRE SHALL BE GROUNDED USING DETERRENT WIRE GROUNDING CLAMP(TYP.), COAT WITH CONDUCTIVE ANTIOXIDANT COMPOUND FENCE FABRIC TO BE GROUNDED USING GROUNDING CLAMPS IN (3) PLACES #2 AWG SOFT DRAWN TINNED SOLID COPPER CONDUCTOR TO BOND FENCE FABRIC TO GROUND CONDUCTOR FENCE POST -EXOTHERMIC WELD #2 AWG BARE COPPER GROUND CONDUCTOR WITH EXOTHERMIC WELD #2 AWG BARE COPPER BURIED GROUND CONDUCTOR TYP. FENCE GROUNDING SCALE: N.T.S.

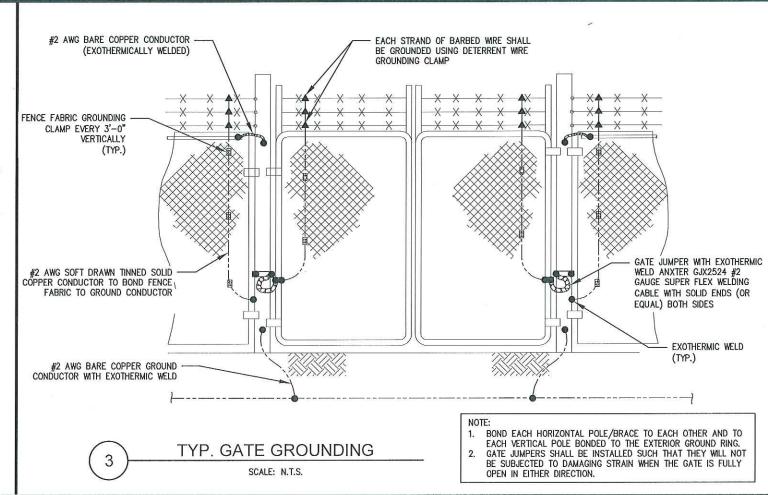



09/11/2017

PE RENEWAL DATE DECEMBER 31, 2018





KGI WIRELESS, INC. 805 LAS CIMAS PKWY BUILDING THREE, SUITE 370 AUSTIN, TX 78746

TEL: 512.345.9595 FAX: 512.345.9898

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10/18/2016

04/03/2017

CONSTRUCTION REV 0 07/20/2017
CONSTRUCTION REV 1 09/11/2017

REVISION

NO DESCRIPTION BY DATE

SHEET TITLE:


GROUNDING DETAILS

SHEET NUMBER:

ISSUED FOR: REVIEW REV B


REVIEW REV C

G3

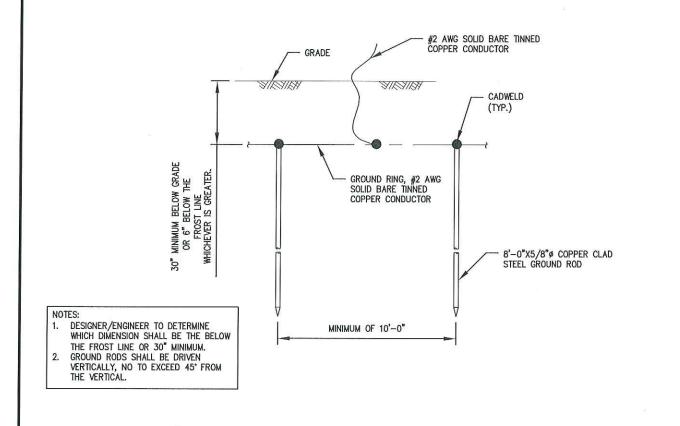


GROUND ROD DETAIL

SCALE: N.T.S.

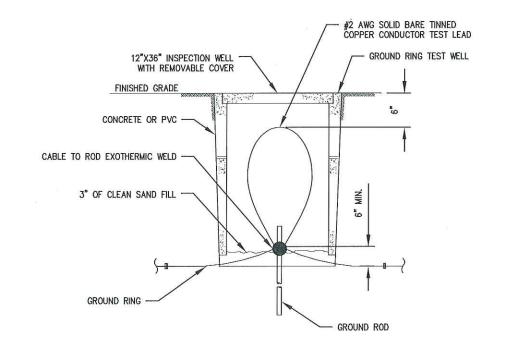

2 TEST WELL DETAIL

SCALE: N.T.S.

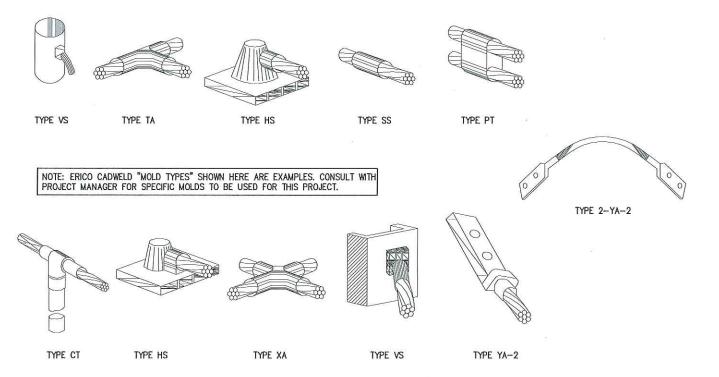

TYP. EXOTHERMIC WELDS

SCALE: N.T.S.



09/11/2017

PE RENEWAL DATE DECEMBER 31, 2018





KGI WIRELESS, INC.
805 LAS CIMAS PKWY
BUILDING THREE, SUITE 370
AUSTIN, TX 78746
TEL: 512.345.9595
FAX: 512.345.9898

AA. 312.343.3030

SITE NAME:

LSC MCNUTT

LOCATION CODE:

300209

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| ISSUED FOR: DATE
| REVIEW REV B | 10/18/2016
| REVIEW REV C | 04/03/2017
| CONSTRUCTION REV 0 | 09/11/2017
| CONSTRUCTION REV 1 | 09/11/2017


REVISION			
NO	DESCRIPTION	BY	DATE


SHEET TITLE:

GROUNDING DETAILS

SHEET NUMBER:

G4

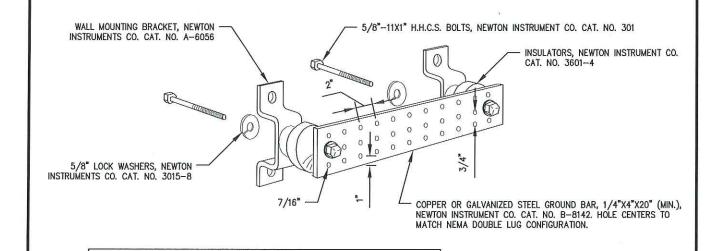

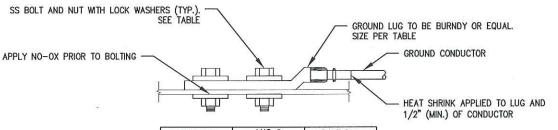

WIRE SIZE	LUG #	BOLT DIA.	
#6 AWG	YA6C2TC14E2	1/4"	
#2 AWG	YA2CL-2TC14	1/4"	
#2 AWG SOLID	YA3C2TC38	3/8"	
#2/0 AWG	YA262LN	1/2"	
#4/0 AWG	YA282LN	1/2"	

TYP GI

HARDWARE DIAMETER SHALL BE A MINIMUM 3/8".


GROUND BAR SHALL BE SIZED TO ACCOMMODATE ALL GROUNDING CONNECTIONS REQUIRED PLUS PROVIDE 50% SPARE CAPACITY.
GROUND BAR SHALL BE NEITHER FIELD FABRICATED NOR NEW HOLES DRILLED.
GROUND LUGS SHALL MATCH THE HOLE SPACING ON THE BAR.

TYP. GROUND BAR DETAIL

SCALE: N.T.S.

TYP. TWO-HOLE LUG DETAIL

SCALE: N.T.S.

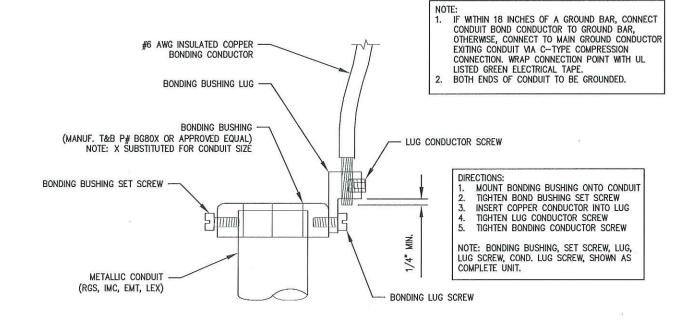

GROUNDING DETAILS
SHEET NUMBER:

ISSUED FOR:

REVIEW REV B

REVIEW REV C

NO DESCRIPTION

SHEET TITLE:

CONSTRUCTION REV 0

CONSTRUCTION REV 1

G5

PE RENEWAL DATE DECEMBER 31, 2018

805 LAS CIMAS PKWY

BUILDING THREE, SUITE 370

AUSTIN, TX 78746 TEL: 512.345.9595 FAX: 512.345.9898

SITE NAME:

LSC MCNUTT

LOCATION CODE:

300209

SITE ADDRESS:

100 AIRPORT ROAD

SANTA TERESA, NM 88008

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REVISION

DATE

10/18/2016

04/03/2017

07/20/2017

09/11/2017

BY DATE

TYP. CONDUIT GROUNDING DETAIL

SCALE: N.T.S.

GENERAL ANTENNA NOTES: 1 CONTRACTOR TO VERIFY MECHANICAL DOWNTILT WITH FINAL SLF/RF ENGINEER 2 DUAL POLAR ANTENNAS REQUIRE TWO RUNS OF COAX PER ANTENNA 3 CONTRACTOR TO VERIFY ALL ACTUAL LENGTHS IN FIELD PRIOR TO INSTALLATION AND NOTIFY THE FIELD ENGINEER FOR VERIFICATION OF SIZES OF CABLES 4 CONTRACTOR TO PROVIDE AS BUILT FOR THE LENGTH OF CABLES UPON COMPLETION OF INSTALLATION 5 CONTRACTOR TO PROVIDE FINAL CABLE LENGTHS AND RETURN LOSSES FOR ALL CABLES ALL AZIMUTHS REFERENCE TRUE NORTH. CONSULT REQUIRED QUADRANGLE MAP FOR

NEW LESSEE RRH & RAYCAP SCHEDULE:


1	NEW LESSEE ANTENNA SCHEDULE:							
LI	TACH EVEL COR)	AZIMUTHS (DGE., TN)	ANTENNA TYPE	ANTENNA QUANTITY	MOUNT TYPE	COAX (QUANTITY) SIZE (NOMINAL)	ESTIMATED COAX CABLE LENGTH	MECHANICAL DOWN TILT
70	0'-0"	0° 130° 260°	8'-0" PANEL ANTENNA	6	SEE ANTENNA MOUNT SCHEDULE	(2) HYBRIFLEX CABLES	100'-0"	REFER TO SLF
NO	NOTES:							
1	FOR EXACT ANTENNA INFORMATION REFER TO THE RF DESIGN							
2	ALL NEW COAX SHALL BE INSTALLED INSIDE MONOPOLE (IF POSSIBLE)							
3	CONT	CONTRACTOR TO INSTALL DIPLEXERS IN SHELTER AND ON TOWER AS REQUIRED BY RF DESIGN (IF APPLICABLE)						

LEVEL (COR)	AZIMUTHS (DGE., TN)	MAKE/MODEL	QUANTITY	
65'-0"	-	Hybrid distribution box	2	
65'-0"	-	REMOTE RADIO HEAD	6	PROPOSED DISTRIBUTION — PROPOS
		(6) PROPOSED P. (3) P. (3) P.	~	EMPTY POLE MOUNT ON SECTOR FRAME

SECT	SECTOR COLOR CODE:				
SECTOR	ANTENNA LOCATIONS	SECOND STRIPE	THIRD STRIPE		
11 5011	1 2	DED ON WHITE ON VEHIOW ON DURNIE	GREEN	-	
ALPHA	3 4	RED OR WHITE OR YELLOW OR PURPLE		GREEN	
DETA	1 2	RED OR WHITE OR YELLOW OR PURPLE	ORANGE	_	
BETA	3 4	RED ON WHITE ON TELLOW ON PONTEE	OTANGE	ORANGE	
041444	1 2	RED OR WHITE OR YELLOW OR PURPLE	BROWN	1	
GAMMA	3 4	NED ON WHILE ON TELLOW ON FORFILE	BROWN	BROWN	

QUANTITY	DESCRIPTION	PART NUMBER(S
1	10'-0" FACE, T-ARM ASSEMBLY KIT (3'-0" STANDOFF) - (1) TRI COLLAR BRACKET - (3) T-ARM ASSEMBLIES	C10-856-601
2	AZIMUTH SWIVEL	C10-113-200

ANTENNA	COLOR	CODE:
ANTENNA FUNCTION	COLOR	
CDMA-800 B-BAND	RED	
CDMA-800 A-BAND	WHITE	
PCS-1900	YELLOW	
LTE-700	PURPLE	
ANTENNA SECTOR		
ALPHA	GREEN	
BETA	ORANGE	
GAMMA	BROWN	

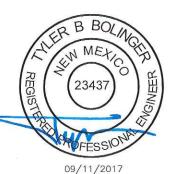

PE RENEWAL DATE DECEMBER 31, 2017





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DATE

ı	NO DESCRIPTION			DVIDATE
		REV	SION	
	CONSTRUCTION	REV	1	09/11/2017
	CONSTRUCTION			07/20/2017
	REVIEW REV C			04/03/2017
1	REVIEW REV B			10/18/2016

NO	DESCRIPTION	BY	DATE
1	REVISED ANTENNA SCH.	IP	09/06/2017
-		-	

SHEET TITLE:

ISSUED FOR:

RF DATA SHEET

SHEET NUMBER:

ANTENNA SECTION @ 70'-0" SCALE: N.T.S.

CONTRACTOR SHALL NOT SUBMIT BIDS OR PERFORM CONSTRUCTION WORK ON THIS PROJECT WITHOUT ACCESS TO THE CURRENT COMPLETE SET OF DRAWINGS LISTED IN THE TITLE—SHEET INDEX

NECESSARY MECHANICAL DECLINATION